32-34 Georges Bay Esplanade St Helens Tasmania 7216 T: 03 6376 7900 ABN 96 017 131 248



Development Applications

Notice is hereby given under Section 57(3) of the *Land Use Planning & Approvals Act 1993* that an application has been made to the Break O' Day Council for a permit for the use or development of land as follows:

DA Number	DA 2024 / 00137
Applicant	Woolcott Land Services
Proposal	Residential – Construction of a Dwelling
Location	100 Grant Street (CT184603/1), Falmouth

Plans and documents can be inspected at the Council Office by appointment, 32 – 34 Georges Bay Esplanade, St Helens during normal office hours or online at <u>www.bodc.tas.gov.au</u>.

Representations must be submitted in writing to the General Manager, Break O'Day Council, 32 -34 Georges Bay Esplanade, St Helens 7216 or emailed to <u>admin@bodc.tas.gov.au</u>, and referenced with the Application Number in accordance with section 57(5) of the abovementioned Act during the fourteen (14) day advertised period commencing on Saturday 24th August, 2024 **until 5pm Friday 6th September, 2024.**

John Brown GENERAL MANAGER



DRAWING SCHEDULE

A00	COVER PAGE
A01	SITE PLAN
A02	CONSTRUCTION PLAN
A03	FLOOR PLAN
A04	ELEVATIONS #1
A05	ELEVATIONS #2
A06	3D PERSPECTIVES
A07	SHADOW PLANS

PROPOSED DWELLING

J. & G. WILLIAMS 100 GRANT STREET FALMOUTH

BREAK O'DAY COUNCIL

PROJECT INFORMATION


BUILDING DESIGNER: ACCREDITATION No: BUILDING CLASS: LAND TITLE REFERENCE NUMBER: DESIGN WIND SPEED: SOIL CLASSIFICATION: CLIMATE ZONE: BUSHFIRE-PRONE BAL RATING: ALPINE AREA: CORROSION ENVIRONMENT: FLOODING: LANDSLIP: DISPERSIVE SOILS: SALINE SOILS: SAND DLINES:	GRANT JAMES CC2211T CLASS 1A 184603/1 N3 TBA 7 N/A N/A SEVERE NO NO UNKNOWN UNKNOWN
SAND DUNES:	NO
MINE SUBSIDENCE: LANDFILL:	NO NO
GROUND LEVELS: ORG LEVEL:	REFER PLAN 75MM ABOVE G

DEVELOPMENT AREA			
Name Area			
PROPOSED DWELLING	118.99 m ²		
DECK	46.84 m ²		
LIVING LANDING	2.00 m ²		
LAUNDRY LANDING 1.44 m ²			
	169.26 m ²		

ISSUED FOR APPROVAL

PFEIFFER

GROUND LEVEL SURFACE

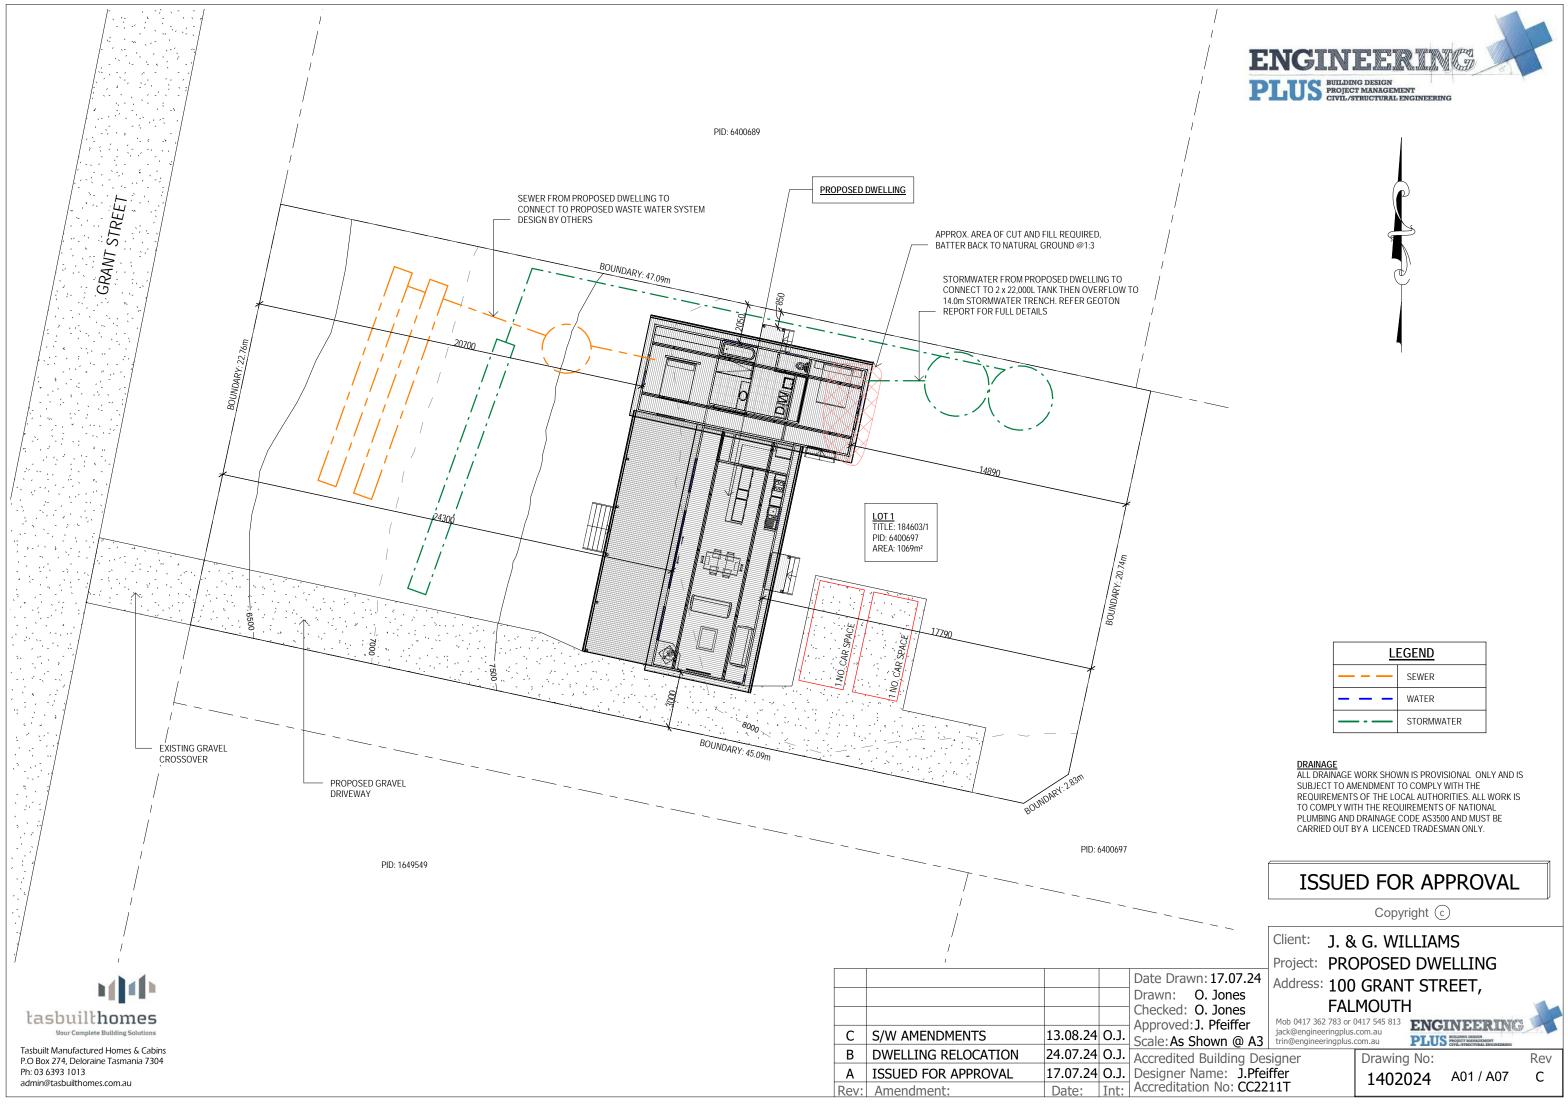






LEGEND			
SEWER			
	WATER		
STORMWATER			



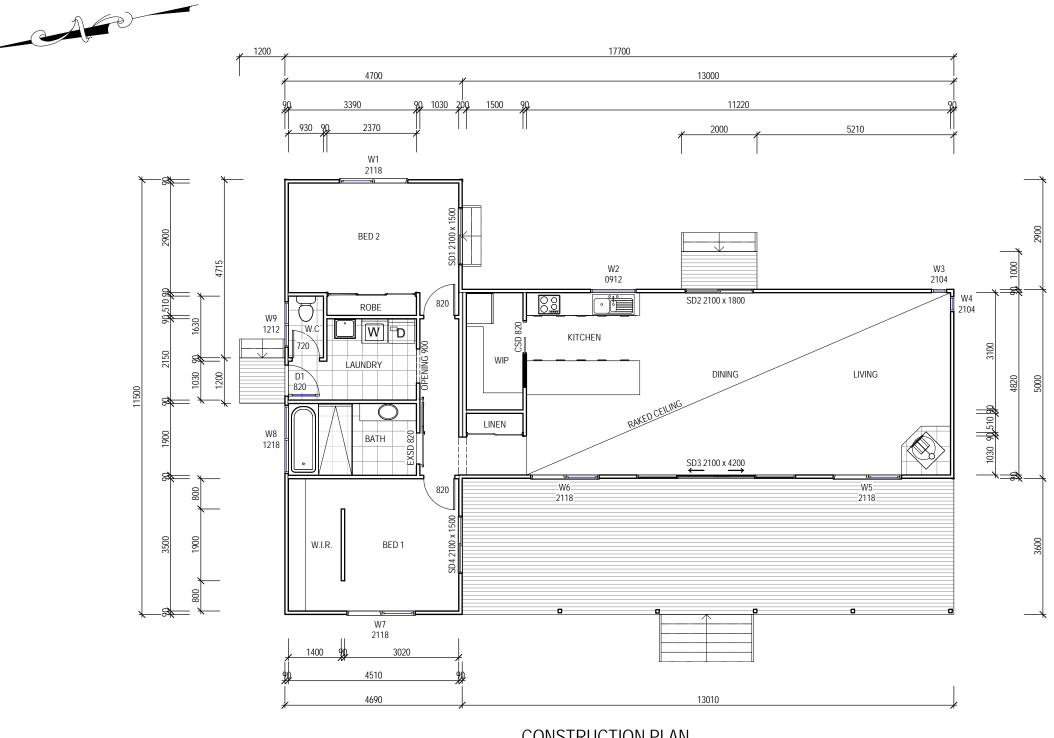

CONSTRUCTION PLAN SCALE 1:100

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Hasbuilthomes	

Tasbuilt Manufactured Homes & Cabins P.O Box 274, Deloraine Tasmania 7304 Ph: 03 6393 1013 admin@tasbuilthomes.com.au

	ling)	dule (Gross Build	Area Scheo	
	Area (sq)	Area	Name	
	12.81	118.99 m ²	PROPOSED DWELLING	
C S	5.04	46.84 m²	DECK	
BC	0.16	1.44 m²	LAUNDRY LANDING	
A I	0.22	2.00 m ²	LIVING LANDING 2.	
Rev' A	18.22	169.26 m ²		

					Date Draw
					Drawn:
					Checked:
	C	S/W AMENDMENTS	13.08.24	0.1.	Approved:
_	0	•			Scale: As S
	В	DWELLING RELOCATION	24.07.24	0.J.	Accredited
	Α	ISSUED FOR APPROVAL	17.07.24	0.J.	Designer N
R	ev:	Amendment:	Date:	Int:	Accreditati




WINDOW SCHEDULE


MARK	HEIGHT	WIDTH	TYPE	U-VALUE	SHGC
W1	2100	1800	DG	4.3	.55
W2	900	1200	DG	4.3	.55
W3	2100	400	DG	4.3	.55
W4	2100	400	DG	4.3	.55
W5	2100	1800	DG	4.3	.55
W6	2100	1800	DG	4.3	.55
W7	2100	1800	DG	4.3	.55
W8	1200	1800	DG	4.3	.55
W9	1200	1200	DG	4.3	.55
*W10	400	1800	DG	4.3	.55
*W11	400	4200	DG	4.3	.55
*W12	400	1800	DG	4.3	.55
SD1	2100	1500	DG	4.0	.61
SD2	2100	1800	DG	4.0	.61
SD3	2100	4200	DG	4.0	.61
SD4	2100	1500	DG	4.0	.61
D1	2100	820	DG	4.0	.61

*REFER ELEVATIONS FOR HIGHLIGHT WINDOWS

DISCLAIMER:

ALL WINDOWS SHOWN ON PLAN ARE APPROX. BASED OFF STANDARD MANUFACTURING SIZES. ALL WINDOW DIMENSIONS TO BE CONFIRMED ON SITE BY BUILDER PRIOR TO ORDERING AND MANUFACTURING.

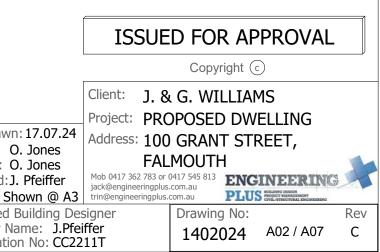

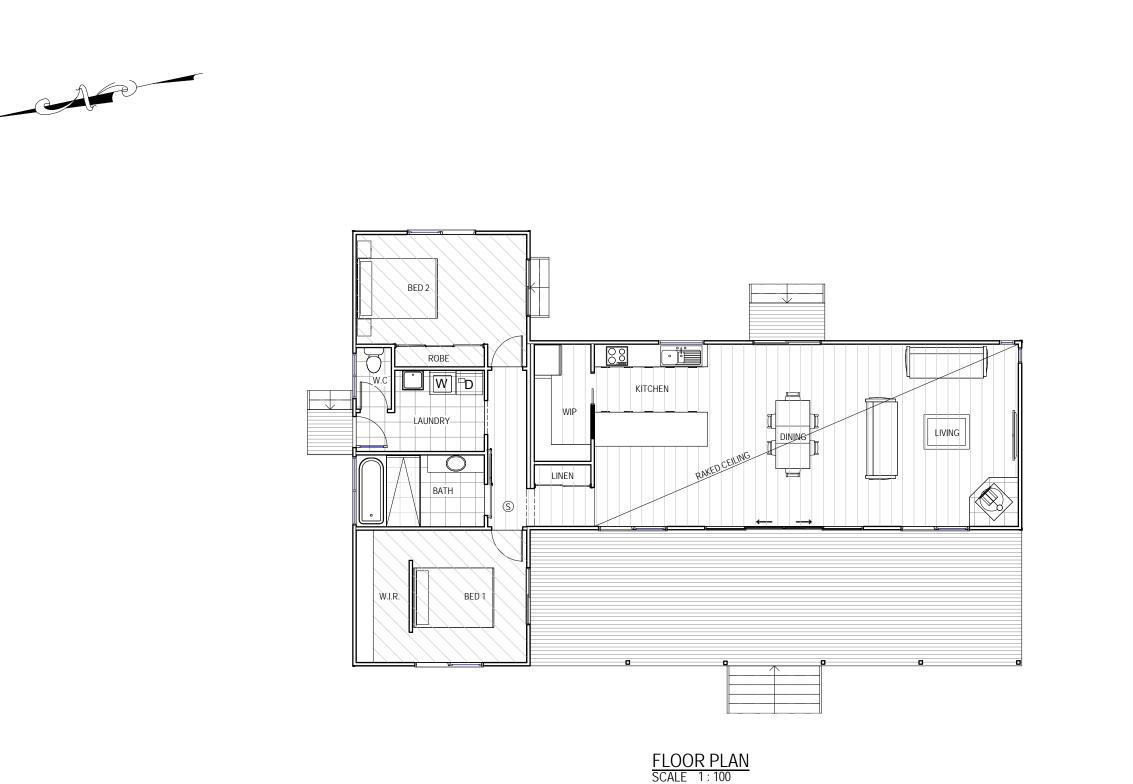

- Add	
tasbuilthomes	
Your Complete Building Solutions	

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Area Schedule (Gross Building)					
Name Area Area (sq)					
PROPOSED DWELLING 118.99 m ² 12.81					
DECK	46.84 m ²	5.04			
LAUNDRY LANDING	1.44 m²	0.16			
LIVING LANDING	2.00 m ²	0.22			
169.26 m ² 18.22					

		-		
				Date Draw
				Drawn:
				Checked:
				Approved:
С	S/W AMENDMENTS	13.08.24	0.J.	Scale: As S
В	DWELLING RELOCATION	24.07.24	0.J.	Accredited
Α	ISSUED FOR APPROVAL	17.07.24	O.J.	Designer N
Rev:	Amendment:	Date:	Int:	Accreditati



FLOOR COVERINGS		
	CARPET	
v v	CONCRETE	
	TIMBER DECKING	
	TILE	
	VINYL TIMBER FLOORING	




EAVE & SOFFIT CONSTRUCTION BCA VOLUME 2 PART 3.5.3.5 EAVE WIDTH - 300MM

SOFFIT / EAVE LINED WITH 'HARDIFLEX' CEMENT SHEETING

admin@tasbuilthomes.com.au

- TRIMMERS LOCATED WITHIN 1200 MM OF EXTERNAL CORNERS TO BE SPACED @ 500 MM CENTERS, REMAINDER OF SHEET 700 MM CENTERS
- FASTENER / FIXINGS WITHIN 1200 MM OF EXTERNAL CORNERS @ 200 MM CENTERS, REMAINDER OF SHEET 300 MM CENTERS

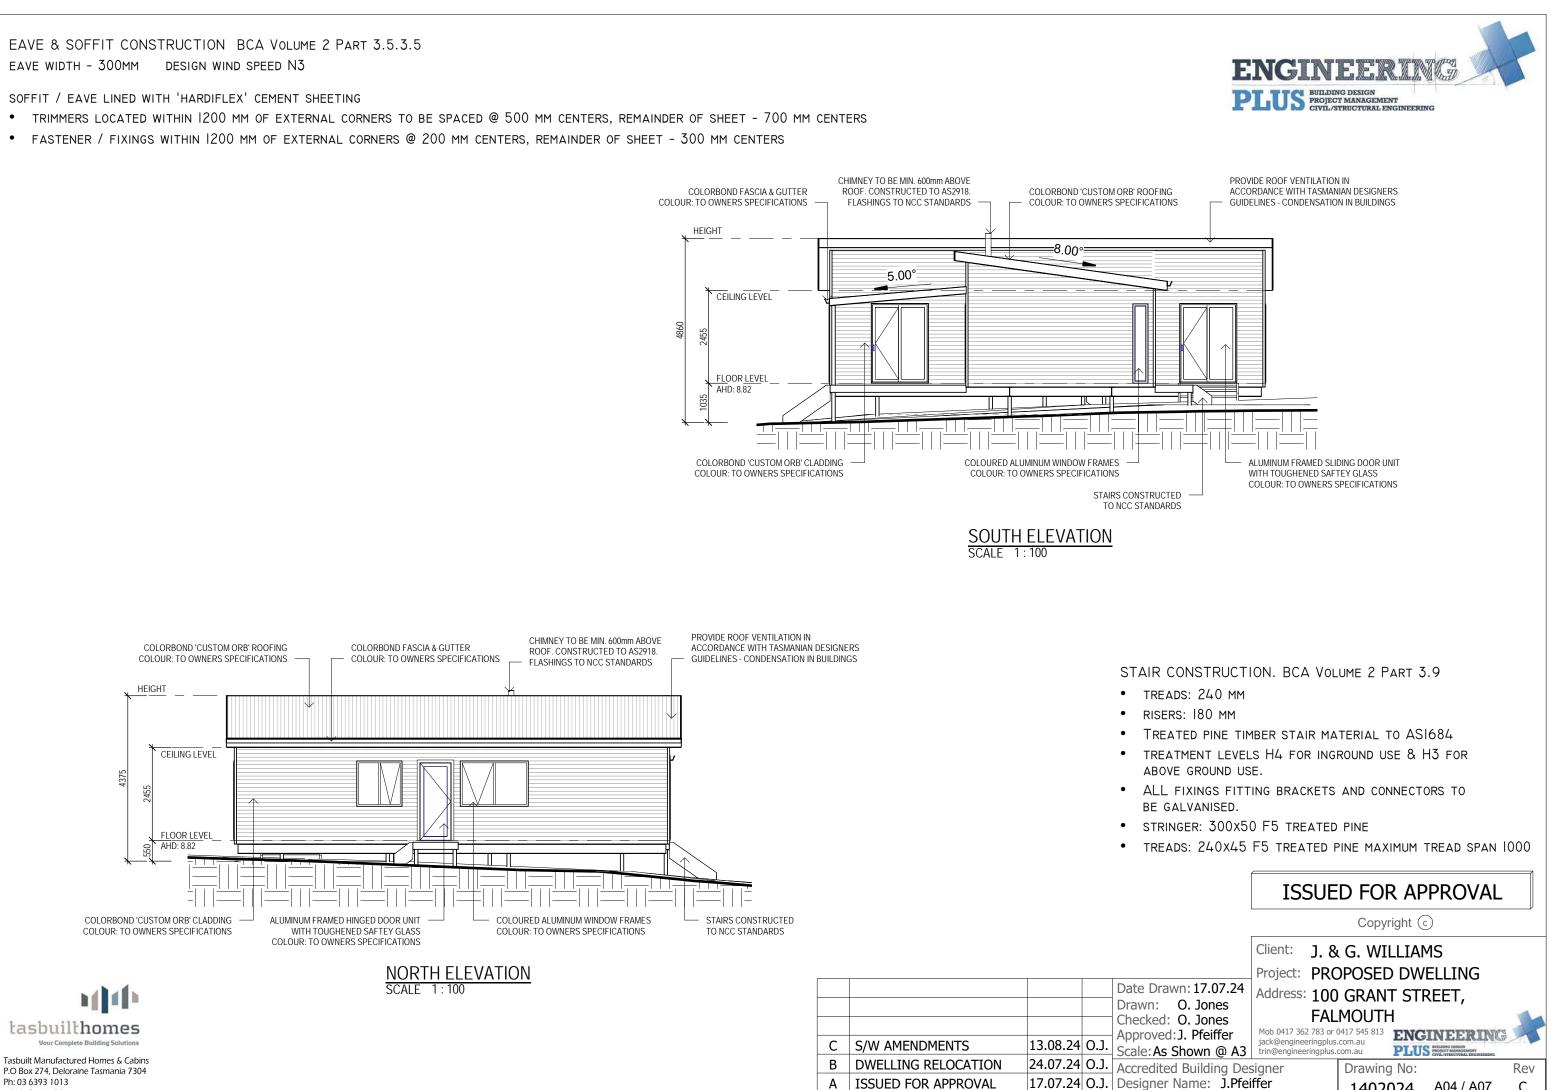

Rev: Amendment:


		ricci cultea ballaning besign
17.07.24	0.J.	Designer Name: J.Pfeiffer
Date:	Int:	Accreditation No: CC2211T

1402024


A04 / A07

С


- VENTS TO BE LOCATED NO GREATER THAN 600 MM FROM AN INTERNAL OR EXTERNAL CORNER.

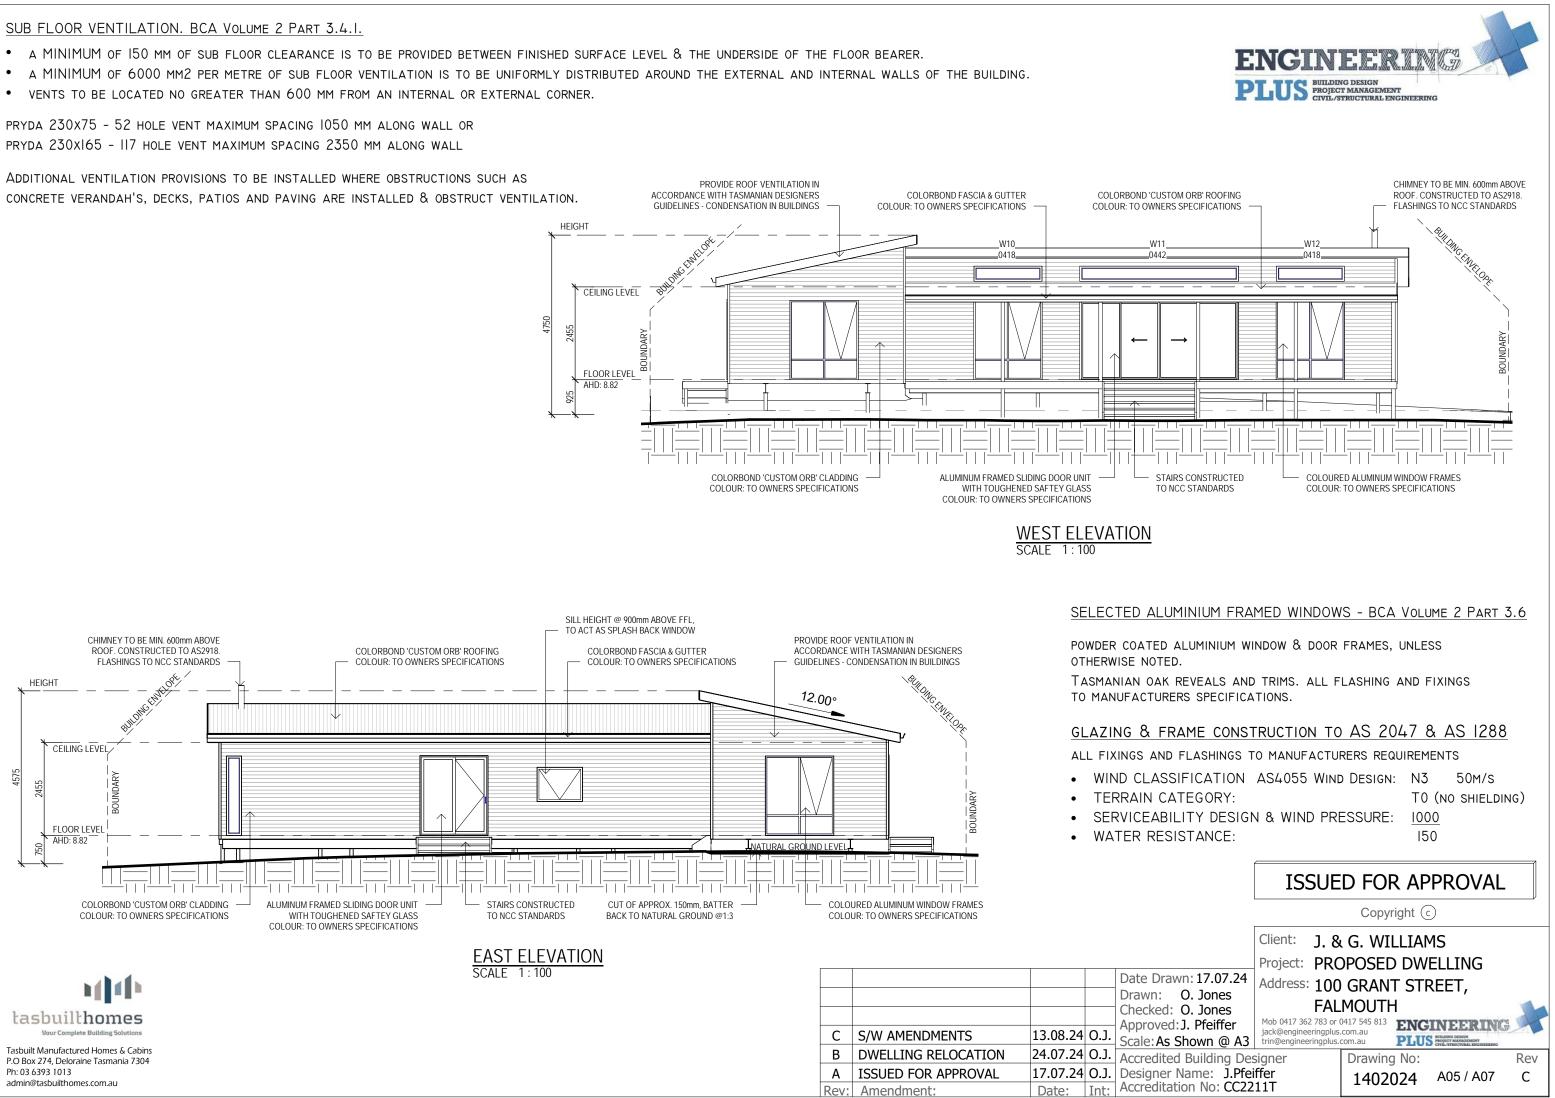



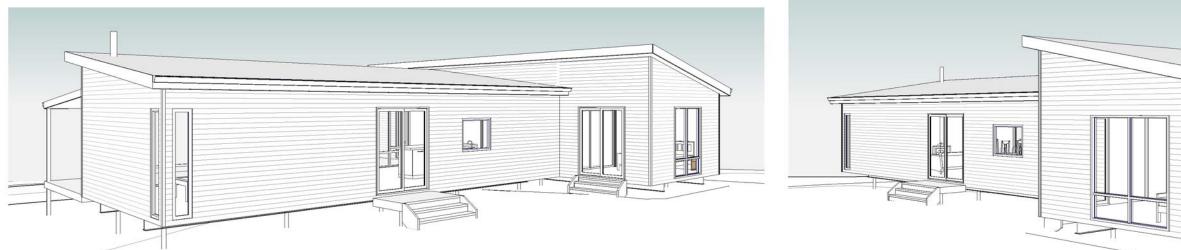

							Project:
						Date Drawn: 17.07.24	Address:
h () ()						Drawn: O. Jones	/ (44) 0001
tasbuilthomes						Checked: O. Jones	
						Approved: J. Pfeiffer	Mob 0417 362
Your Complete Building Solutions		С	S/W AMENDMENTS	13.08.24	0.J.	Scale: As Shown @ A3	jack@enginee
Tasbuilt Manufactured Homes & Cabins	В	В	DWELLING RELOCATION	24.07.24	0.J.	Accredited Building De	cianor
P.O Box 274, Deloraine Tasmania 7304						Accircuited building De	
Ph: 03 6393 1013	A	4	ISSUED FOR APPROVAL	17.07.24	0.J.	Designer Name: J.Pfe	iffer
admin@tasbuilthomes.com.au	Re	ev:	Amendment:	Date:	Int:	Accreditation No: CC22	211T

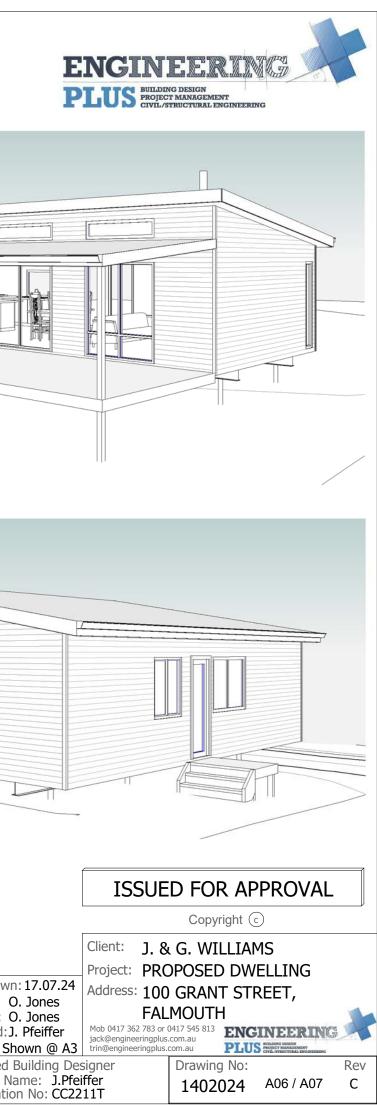




admin@tasbuilthomes.com.au

17.07.24O.J.Designer Name:J.PfeifferDate:Int:Accreditation No: CC2211T

Rev: Amendment:

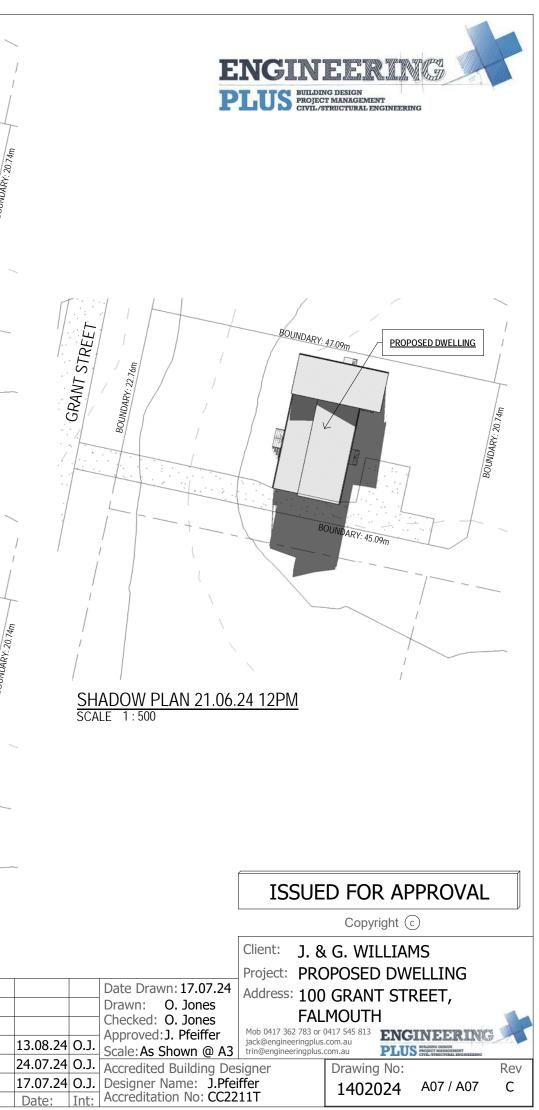



July 2024

PLANNING Report

SINGLE DWELLING

100 Grant Street FALMOUTH





Prepared by Woolcott Land Services Pty Ltd ABN 63 677 435 924

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East Coast office

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Job Number: L240720 Prepared by: Michelle Schleiger (michelle@woolcott.au) Town Planner

Rev.no	Description	Date
1	Review	24 July 2024
2	Draft	
3	Final	25 July 2024
4	RFI	13 August 2024

Contents

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1. Introduction

This report has been prepared in support of a planning permit application under Section 57 of the *Land Use Planning and Approvals Act 1993*.

Proposed development

Building and works - development of a single dwelling

This application is to be read in conjunction with the following supporting documentation:

Document	Consultant
Proposal Plan	Engineering Plus / Tasbuilt Homes

2. Subject site and proposal

2.1 Site details

Address	100 Grant Street, Falmouth TAS 7215		
Property ID	6400697		
Title	184603/1		
Land area	1069m ²		
Planning Authority	Break O' Day Council		
Planning Scheme	Tasmanian Planning Scheme – Break O' Day (Scheme)		
Easements	None on folio plan		
Application status	Discretionary application		
Existing Access	Single crossover from Grant Street		
Zone	Low Density Residential		
General Overlay	None		
Overlays	No overlays		
Existing development	Vacant land		
Existing services and infrastructure			

Water	Not serviced
Sewer	Not serviced
Stormwater	Roadside drain

2.2 Proposal

The proposal is for the development of a single dwelling.

The dwelling will have 2 bedrooms, 1 bathroom, living areas, kitchen and laundry and will include a decked area. The building has an area of 118.99m².

The proposal includes on site servicing for water and sewer and stormwater.

2.3 Subject site

The site is a single lot of 1069m² on the east side of Grant Street. The site is lightly sloped downwards to the north west. The surrounding area is developed to residential use, though some lots are vacant.



Figure 1 Aerial view of the subject site (Source: LIST)

3. Zoning and overlays

3.1 Zoning

The site is zoned Low Density Residential under the Scheme.



Figure 2 Zoning of the subject site and surrounding area (Source: LIST)

3.2 Overlays

The subject site includes no overlays.

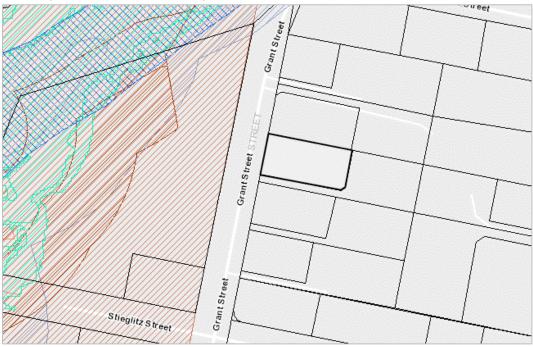


Figure 3 Overlays affecting the subject site (Source: LIST)

4. Planning Scheme Assessment

4.1 Zone assessment

10.0 Low Density Residential Zone


10.1 Zone Purpose

10.1.1	To provide for residential use and development in residential areas where there are infrastructure or environmental constraints that limit the density, location or form of development
10.1.2	To provide for non-residential use that does not cause an unreasonable loss of amenity, through scale, intensity, noise, traffic generation and movement, or other off site impacts.
10.1.3	To provide for Visitor Accommodation that is compatible with residential character.

Response

The proposed residential use and development is in accord with the purpose of the zone.

10.2 Use Table

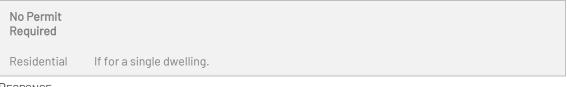

Response

The proposed Use is a *No Permit Required* Use.

10.4 Development Standards for Dwellings

10.4.2 Building height

Objective

That the height of dwellings is compatible with the streetscape and do not cause an unreasonable loss of amenity for adjoining properties.

Acceptable Solutions		Performance Criteria			
A1	A dwelling must have a building height not more than 8.5m.	P1	The height of dwellings must be compatible with the streetscape and no cause an unreasonable loss of amenity to adjoining properties having regard to a) the topography of the site; b) the height of buildings on the site		
				and adjacent properties;	
			c)	the bulk and form of existing and proposed buildings;	
			d)	sunlight to habitable rooms and private open space of dwellings; and	

	(e) any overshadowing of adjoining properties.

Response

A1 The acceptable solution is achieved. The dwelling is 4.8m in height at the highest point.

Objective							
That the siting of dwellings is compatible with the streetscape and does not cause an unreasonable loss of amenity for adjoining properties.							
Acceptable Solutions		Perfo	Performance Criteria				
A1	Dwellings, excluding protrusions that extend not more than 0.9m into the frontage setback, must have a setback from a frontage not less than 8m	P1	1 The siting of a dwelling must be compatible with the streetscape and character of development existing on established properties in the area, havin regard to:				
			a)	the topography of the site;			
			b)	the setbacks of surrounding buildings;			
			c)	the height, bulk and form of existing and proposed buildings;			
			d)	the appearance when viewed from roads and public open space adjacent to the site; and			
			e)	(e) the safety of road users.			

Response

A1 The acceptable solution is achieved. The dwelling has a front setback of 20m+.

A2 Dwellings, excluding outbuildings with a building height of not more than 2.4m and protrusions that extend not more than 0.9m horizontally from the building, must have a setback from side and rear boundaries of not less than 5m.	P2	anι	e siting of a dwelling must not cause unreasonable loss of amenity to pining properties, having regard to: the topography of the site; the size, shape and orientation of the site; the setbacks of surrounding buildings; the height, bulk and form of existing and proposed buildings; the existing buildings and private open space areas on the site; sunlight to private open space and windows of habitable rooms on adjoining properties; and the character of development existing on established properties in the area.
--	----	-----	--

RESPONSE

- P2 The performance criteria are addressed.
 - a. The topography has little bearing on the reduced setbacks.
 - b. The site is rectangular with a width of 22.76m (at the frontage). The width of the dwelling encroaches into the side setback areas.
 - c. The surrounding lots demonstrate instances of similar setbacks. The land adjoining to the north is vacant.
 - d. The surrounding development is similar to the proposed, being predominantly single or double storey dwellings.
 - e. The site is currently vacant.
 - f. Due to the orientation of the site, the proposed is unlikely to overshadow adjoining lots. The south side is buffered by the access strip.
 - g. The surrounding built character is similar to the proposed in form, style and bulk. Similar setbacks due to lot shape and dimension is demonstrated in the area.

10.4.4 Site coverage

Objective						
That site coverage:						
a) is consistent with the character of existing development in the area;						
b) provides sufficient area for private open space and landscaping; and						
c) assists with the management of stormwater r	unoff.					
Acceptable Solutions	Performance Criteria					
A1 Dwellings must have a site coverage of not more than 30%.	P1 The site coverage of dwellings must be consistent with that existing on established properties in the area, having regard to:					
	a) the topography of the site;					
	 b) the capacity of the site to absorb runoff; 					
	c) the size and shape of the site;					
	 the existing buildings and any constraints imposed by existing development; 					
	 e) the provision for landscaping and private open space; 					
	f) the need to remove vegetation; and					
	g) the site coverage of adjacent properties					

RESPONSE

A1 The acceptable solution is achieved.

The site coverage is equivalent to 11 percent.

10.4.5 Frontage fences for all dwellings

Objective					
 The height and transparency of frontage fences: a. provides adequate privacy and security for residents; b. allows the potential for mutual passive surveillance between the road and the dwelling; and c. is reasonably consistent with that on adjoining properties. 					
Acceptable Solutions	Performance Criteria				
A1 No Acceptable Solution.	 P1 A fence (including a free-standing wall) for a dwelling within 4.5m of a frontage must: a) provide for security and privacy, while allowing for passive surveillance of the road; and b) be consistent with the height and transparency of fences in the street, having regard to: the topography of the site; and traffic volumes on the adjoining road. 				

Response

A1 The acceptable solution is achieved – no front fences are included in this proposal.

4.2 Code Assessment

C2.0 Parking and Sustainable Transport Code

C2.5 Use Standards

RESPONSE

- A1 The acceptable solution is achieved. There are two spaces provided for on the site which meets the requirement under Table C2.1.
- C2.6 Development standards for buildings and works
- C2.6.1 Construction of parking areas

RESPONSE

- P1 The proposed driveway and parking area are to be constructed from gravel. This is in line with the existing vehicle crossing. The driveway would be identifiable as the vehicle access point and it will be constructed for all weather conditions.
 - a. The nature of the use is residential.

- b. The topography of the site has little bearing on the access.
- c. Drainage is to the roadside. Any run-off not absorbed will flow to the roadside as the land is sloped (lightly) in that direction.
- d. The existing crossover is gravel so the spread of debris to the road is not increased from the existing.
- e. Gravel made driveways are known to trap dust and reduce dust generation.
- f. The nature of the proposed surfacing is normal for a residential development in a low density development area.

C2.6.2 Design and layout of parking areas

Response

A1 Parking and access provision is compliant and a turning area is provided.

C2.6.3 Number of accesses for vehicles

Response

A1 The site has an existing single access point.

3. Conclusion

This application is for a single dwelling. The proposed is in accord with the provisions of the Scheme and a planning permit is sought from Council.

Annexures

Annexure 1 Copy of Title plan and Folio text

Annexure 2 Proposal Plan