32-34 Georges Bay Esplanade St Helens Tasmania 7216 T: 03 6376 7900 ABN 96 017 131 248



#### **Development Applications**

Notice is hereby given under Section 57(3) of the Land Use Planning & Approvals Act 1993 that an application has been made to the Break O' Day Council for a permit for the use or development of land as follows:

**DA Number** DA 2024 / 00106

**Applicant BVZ** Design

**Proposal** Residential – New Dwelling & Carport Location 191 Scamander Avenue, Scamander

Plans and documents can be inspected at the Council Office by appointment, 32 - 34 Georges Bay Esplanade, St Helens during normal office hours or online at www.bodc.tas.gov.au.

Representations must be submitted in writing to the General Manager, Break O'Day Council, 32 -34 Georges Bay Esplanade, St Helens 7216 or emailed to <a href="mailto:admin@bodc.tas.gov.au">admin@bodc.tas.gov.au</a>, and referenced with the Application Number in accordance with section 57(5) of the abovementioned Act during the fourteen (14) day advertised period commencing on Saturday 20<sup>th</sup> July, 2024 until 5pm Friday 2<sup>nd</sup> August, 2024.

John Brown **GENERAL MANAGER**  LEGEND PAGE 1# COVER PAGE

PAGE 2# LOCALITY PLAN

PAGE 3# EXISTING SITE SURVEY PLAN

PAGE 4# SITE PLAN

PAGE 5# SOIL AND WATER MANAGEMENT PLAN

PAGE 6# FLOOR PLAN

PAGE 7# FLOOR PLAN WITH DIMENSIONS

PAGE 8# ELEVATIONS PAGE 9# ROOF PLAN

COUNCIL - BREAK ODAY COUNCIL

ZONE - GENERAL RESIDENTIAL


CODE — BUSHFIRE PRONE AREA

STORMWATER MANAGEMENT
 SPECIFIC AREA PLAN BRE-S2.0

LANDSLIDE BAND - NIL

TITLE REF. = 12619/16

# PROPOSED DWELLING FOR R SHAW AT 191 SCAMANDER AVENUE SCAMANDER 7215

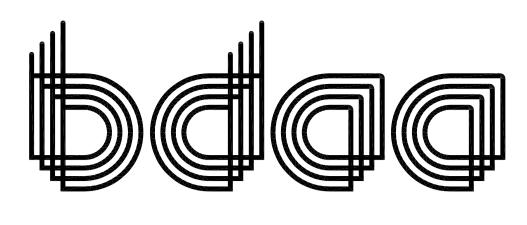

### BUILDING DESIGNERS ASSOCIATION OF AUSTRALIA

ALPINE AREA - N/A LESS THAN 900m AHD

OTHER HAZARDS - N/A

ALL DIMENSIONS SHOWN ARE TO OUTSIDE OF BRICKWORK CLADDING OR TIMBER FRAMING ON CLAD HOUSES UNLESS NOTED OTHERWISE

CONFIRM ALL DIMENSIONS AND SERVICES ON SITE PRIOR TO COMMENCEMENT OF WORKS

IF IN ANY DOUBT ABOUT BEARING AND BOUNDARIES THEN THESE MUST BE CONFIRMED ONSITE BY A SURVEYOR PRIOR TO SETOUT

ENSURE DRAWINGS USED ONSITE ARE STAMPED 'APPROVED' PLANS BY BUILDING SURVEYOR AND PERMIT AUTHORITY

H4D9 CONDENSATION MANAGEMENT TO BE COMPLIANT WITH NCC PART 10.8 CONDENSATION MANAGEMENT. NOTES

(1)REFER TO THE GUIDANCE IN THE "CONDENSATION IN BUILDINGS TASMANIAN DESIGNERS' GUIDE" — CURRENT VERSION AVAILABLE AT WWW.CBOS.TAS.GOV.AU. THIS GUIDE MUST BE READ IN CONJUNCTION WITH THE NCC.

IF ANY DISCREPANCIES, APPARENT ERROR, ANOMALY OR AMBIGUITY WITHIN THE DOCUMENTATION IS FOUND. THE DESIGNER IS TO BE CONTACTED PRIOR TO ANY MORE CONSTRUCTION CONTINUING.

ENSURE THAT DRAWINGS ARE NOT SCALED AND THAT THE NOTED DIMENSIONS ARE USED FOR ACCURACY. IF IN ANY DOUBT CONTACT DESIGNER

REVISION NUMBER	DATE
REVISION 1	12 / 05 / 2024
REVISION 2	02 / 06 / 2024
REVISION 3	05 / 06 / 2024

(C) BRADLEY VAN ZETTEN 2024


THE DESIGN, DETAILS AND SPECIFICATIONS ON THIS PLAN ARE PROJECT SPECIFIC AND MUST NOT BE USED ON ANY OTHER WITHOUT EXPRESS PERMISSION OF THE AUTHOR.



# BRADLEY VAN ZETTEN

4 EDEN HILLS DRIVE
RIVERSIDE 7250
P. 0407 272 381
E. BVZDESIGNS@GMAIL.COM
LICENCE NUMBER 957699796



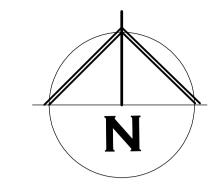

BASE IMAGE OBTAINED FROM WWW.THELIST.TAS.GOV.AU ©STATE OF TASMANIA

"THE LIST" (LAND INFORMATION SYSTEM TASMANIA) COPYRIGHT TO LAND TASMANIA AS THE CREATOR



#### **BRADLEY VAN ZETTEN**

LICENCE NUMBER 957699796

PROJECT: PROPOSED DWELLING

FOR R SHAW

AT 191 SCAMANDER AVENUE SCAMANDER 7215

CALITY PLAN

v. Z.


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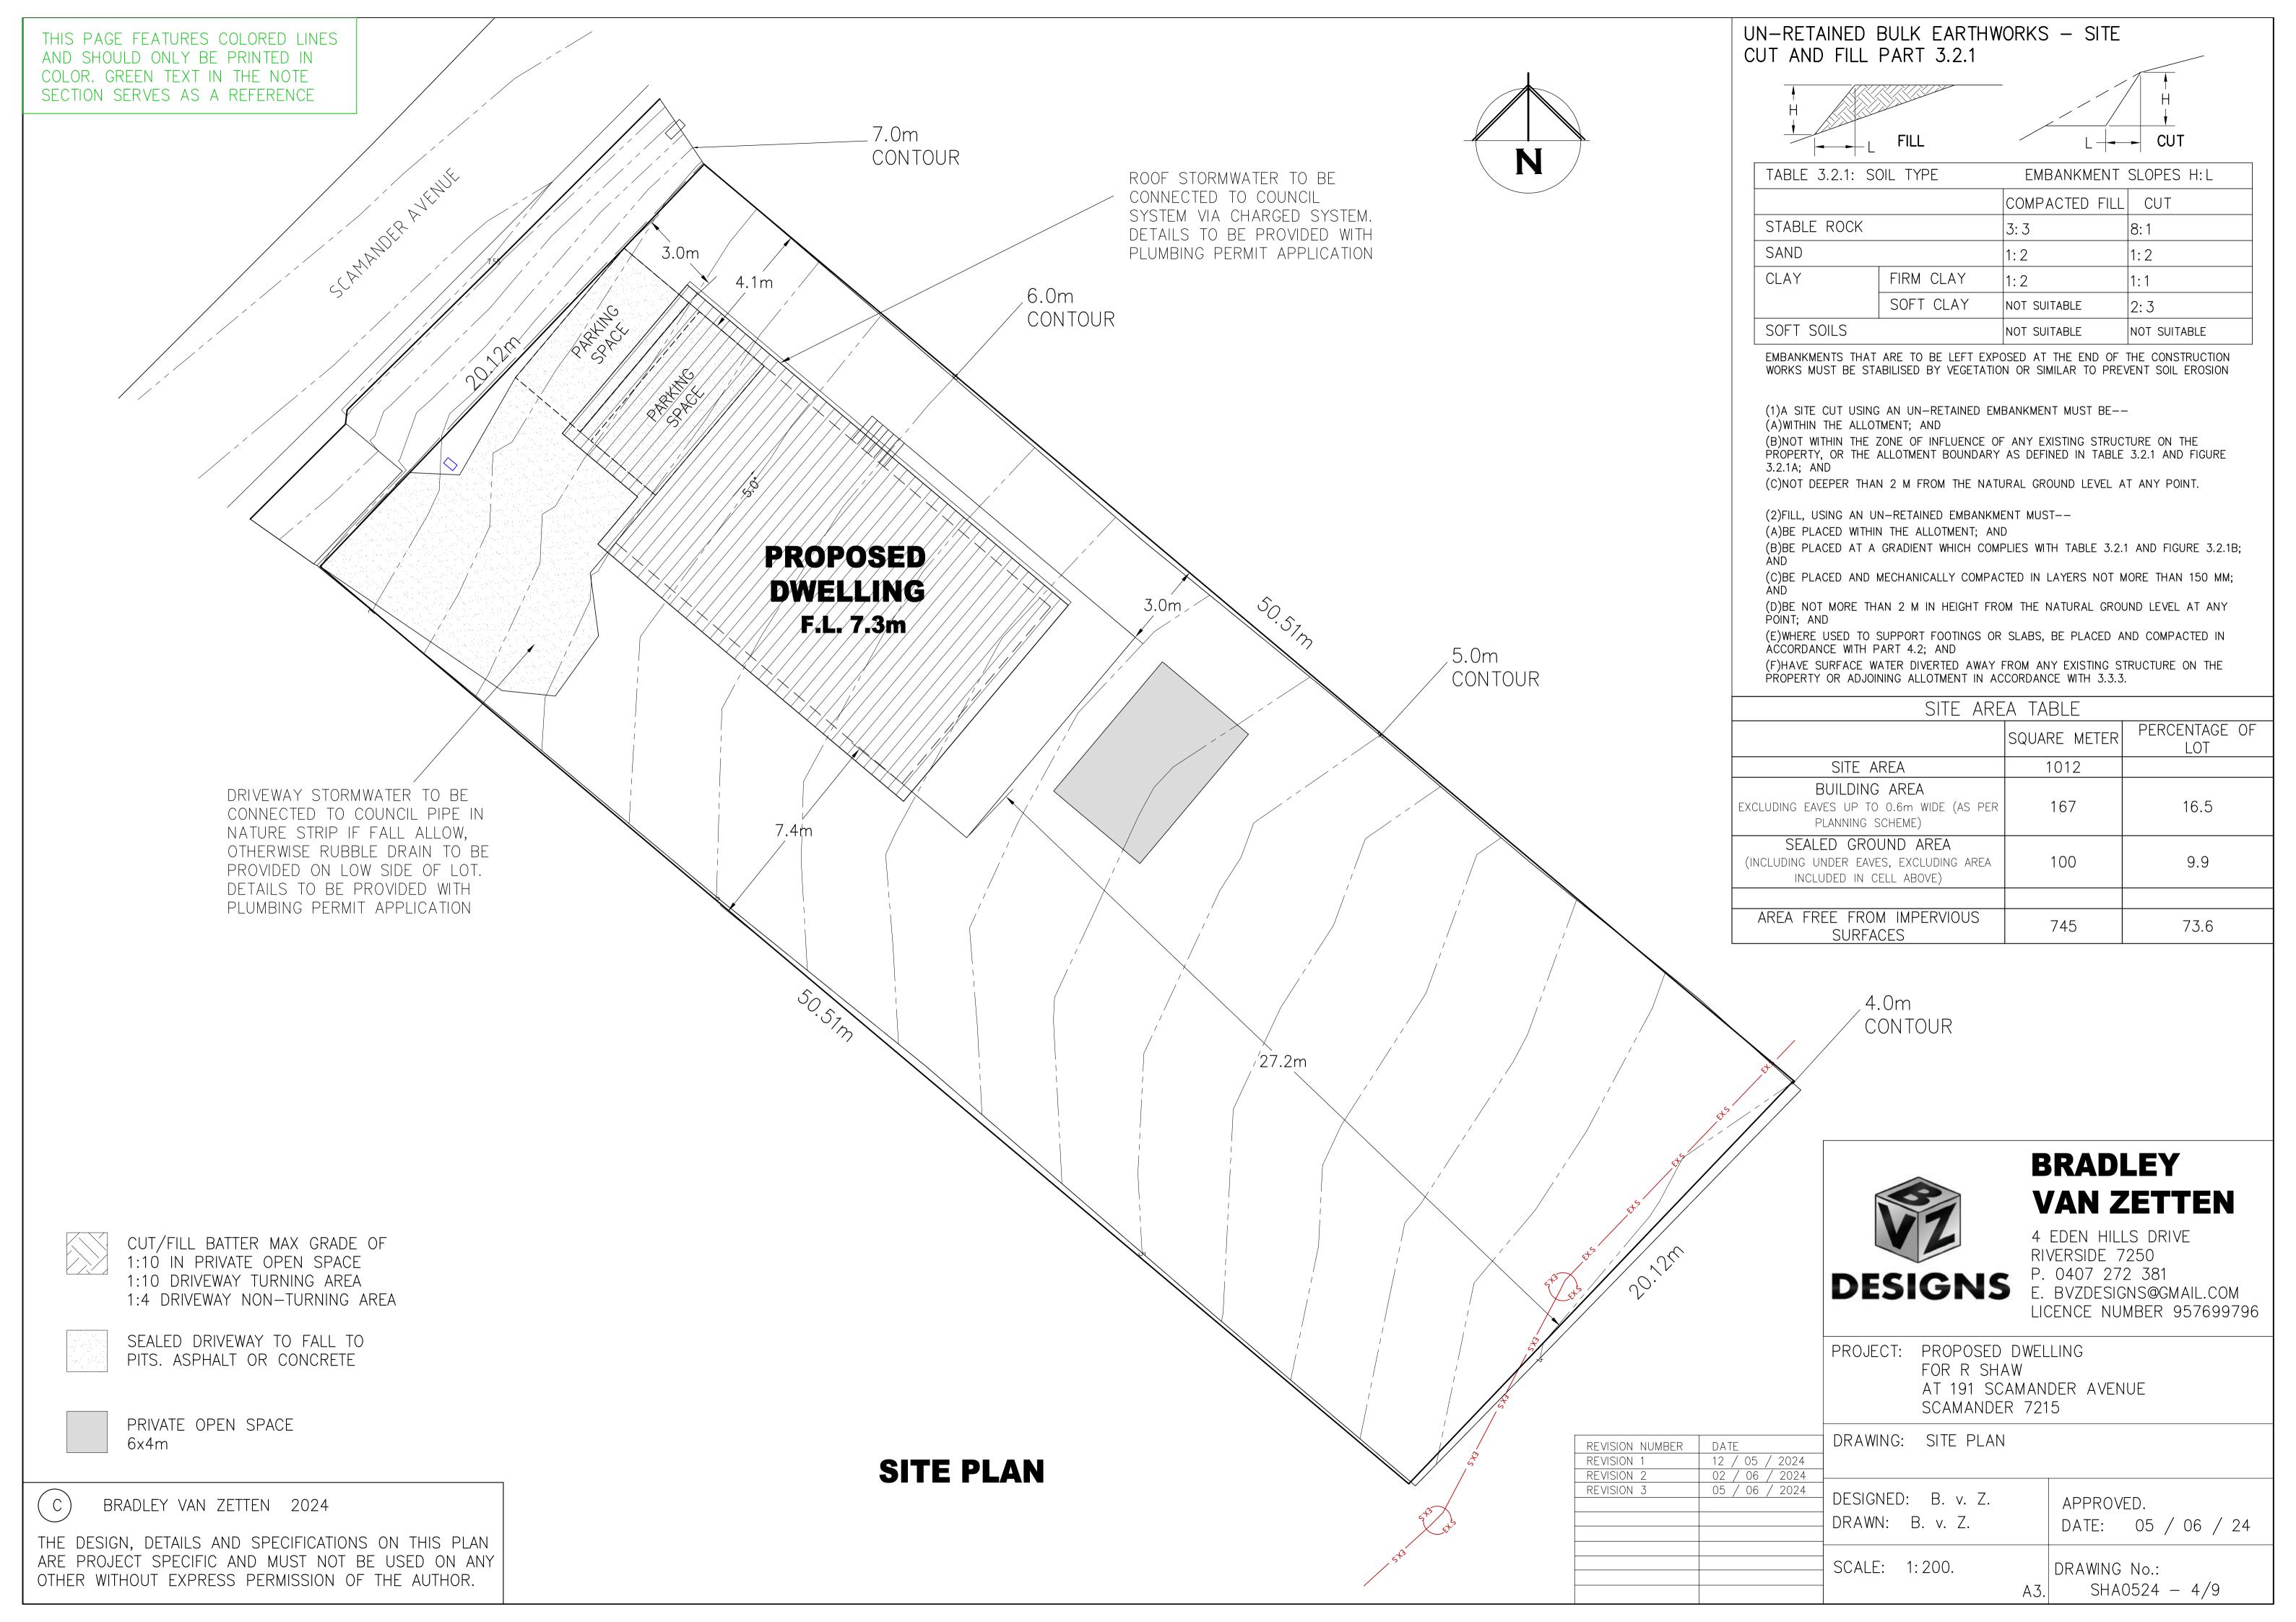
DATE: 05 / 06 / 24


DRAWING No.: A3. SHA0524 - 2/9


**LOCALITY PLAN** 


REVISION NUMBER	DATE	DRAWING:	LOC
REVISION 1	12 / 05 / 2024		
REVISION 2	02 / 06 / 2024		
REVISION 3	05 / 06 / 2024	DESIGNED DRAWN:	
		SCALE:	1:1000




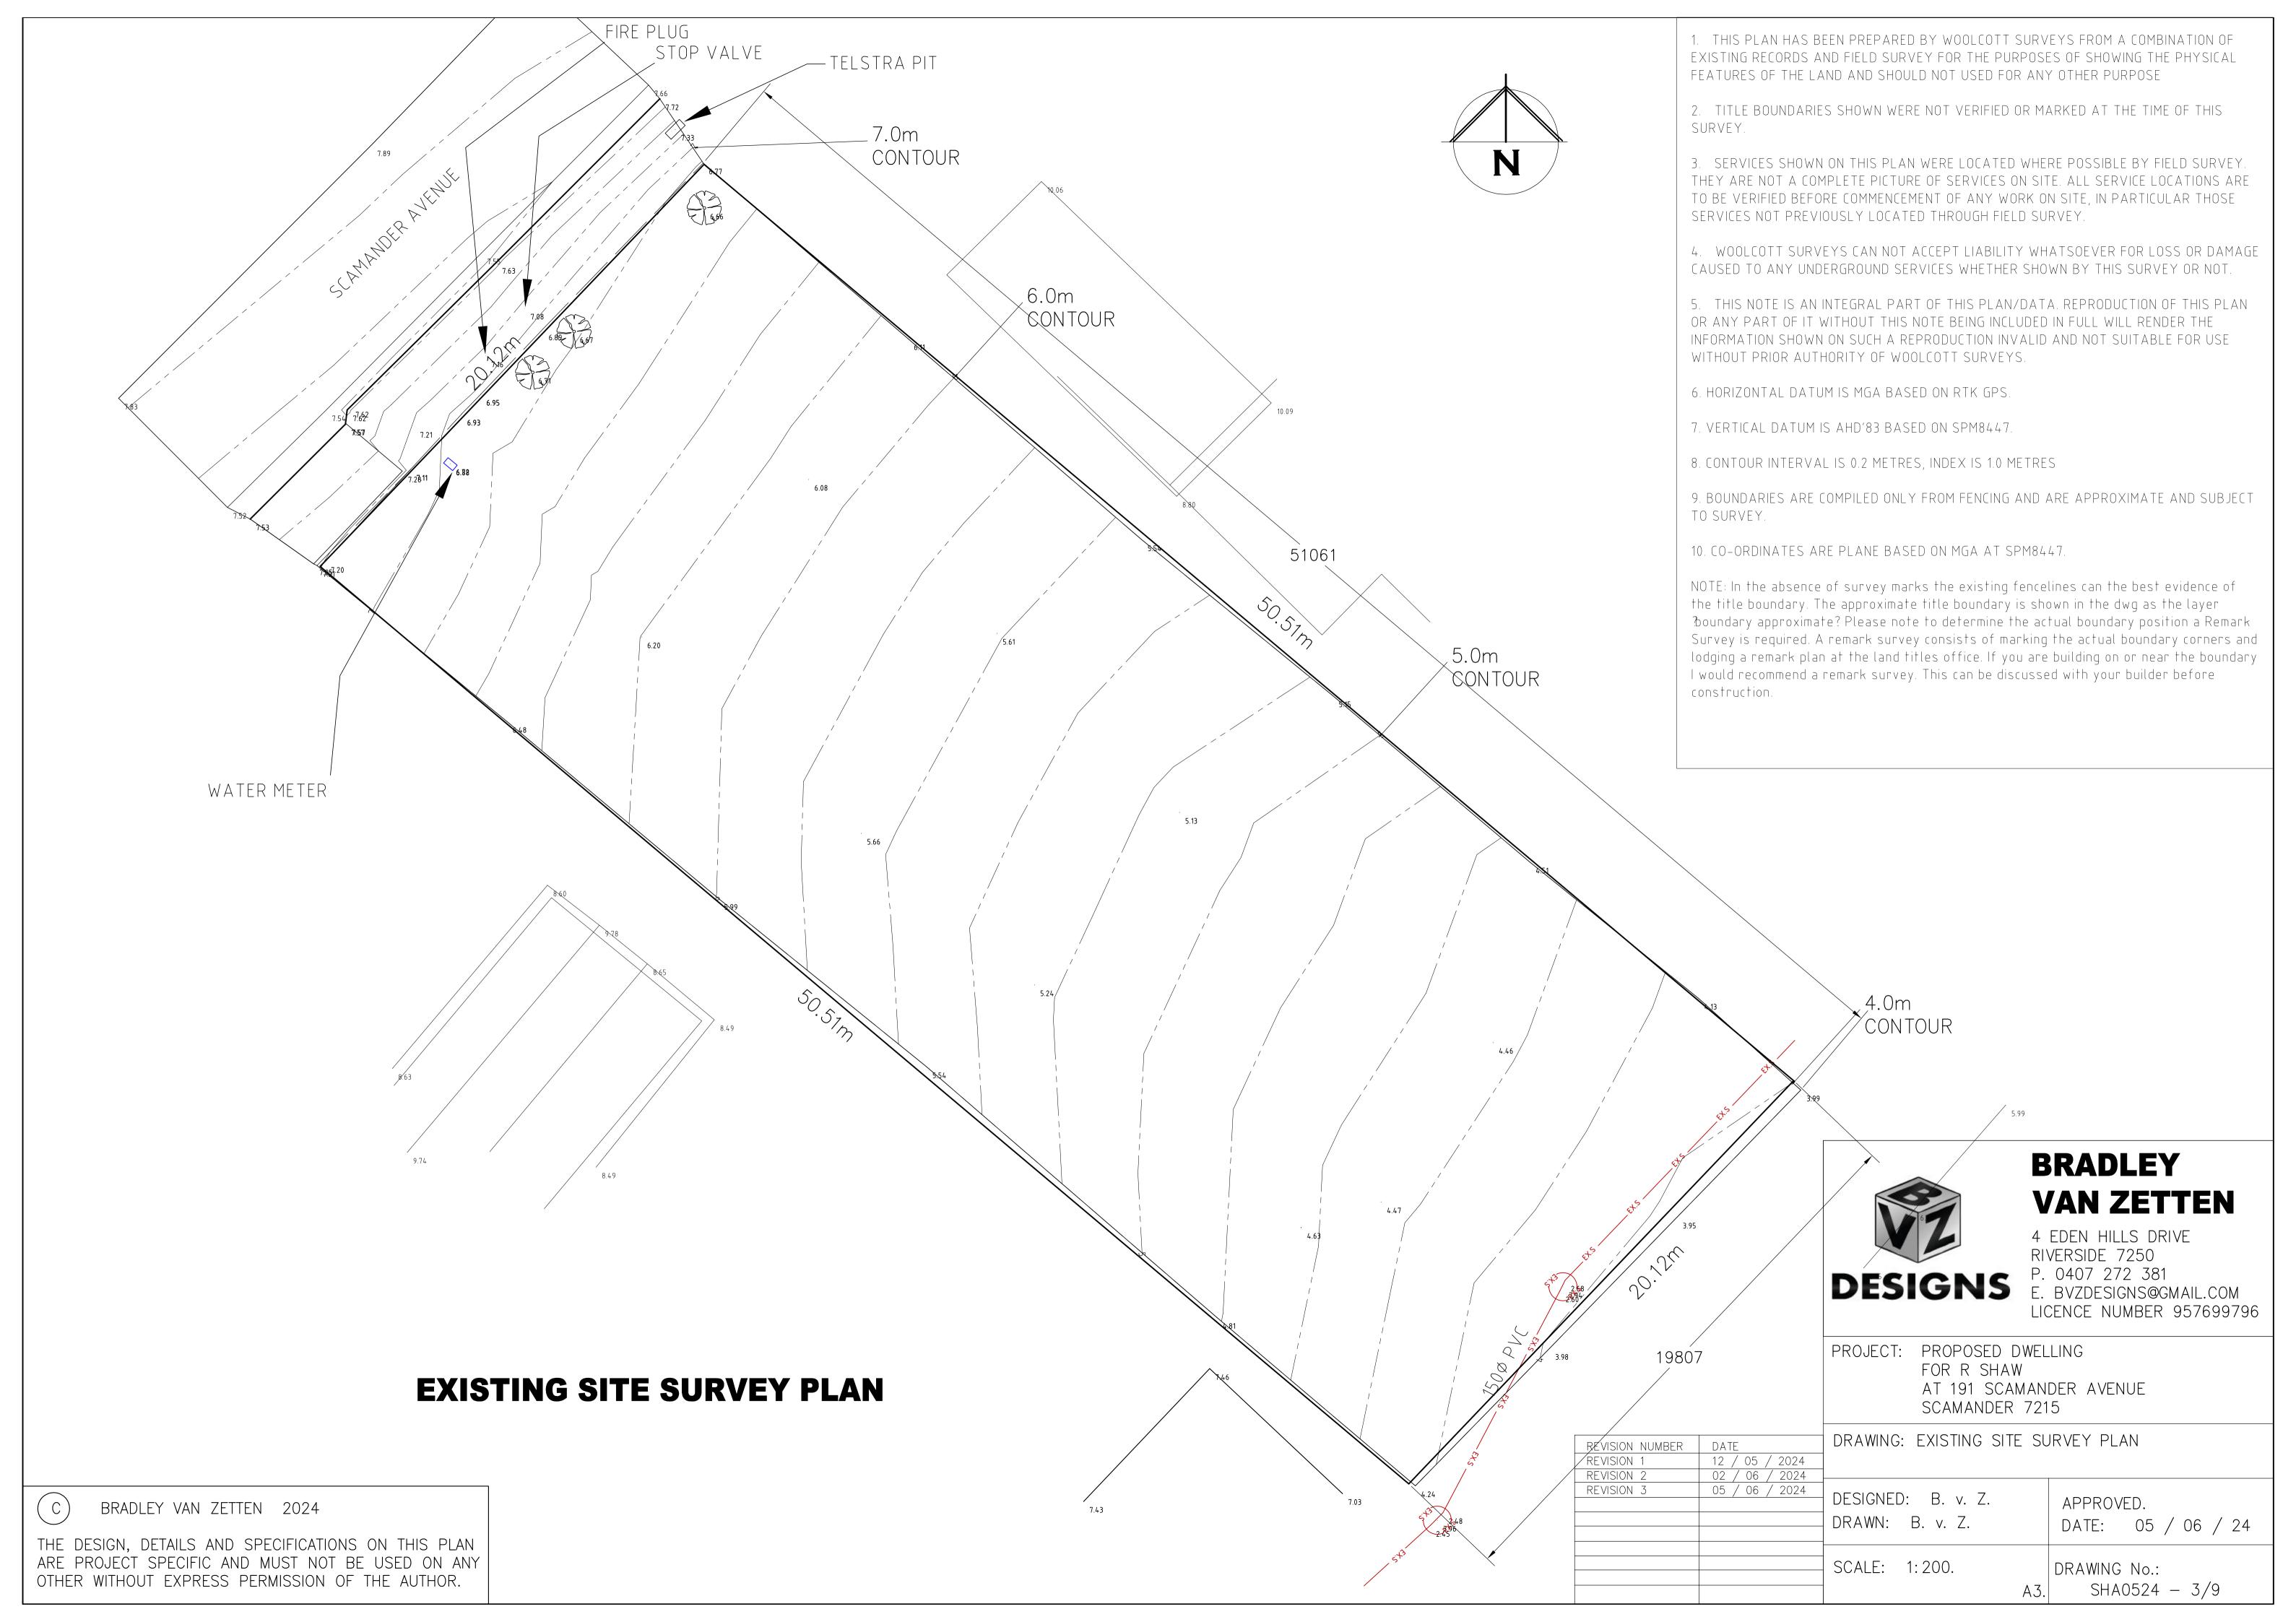

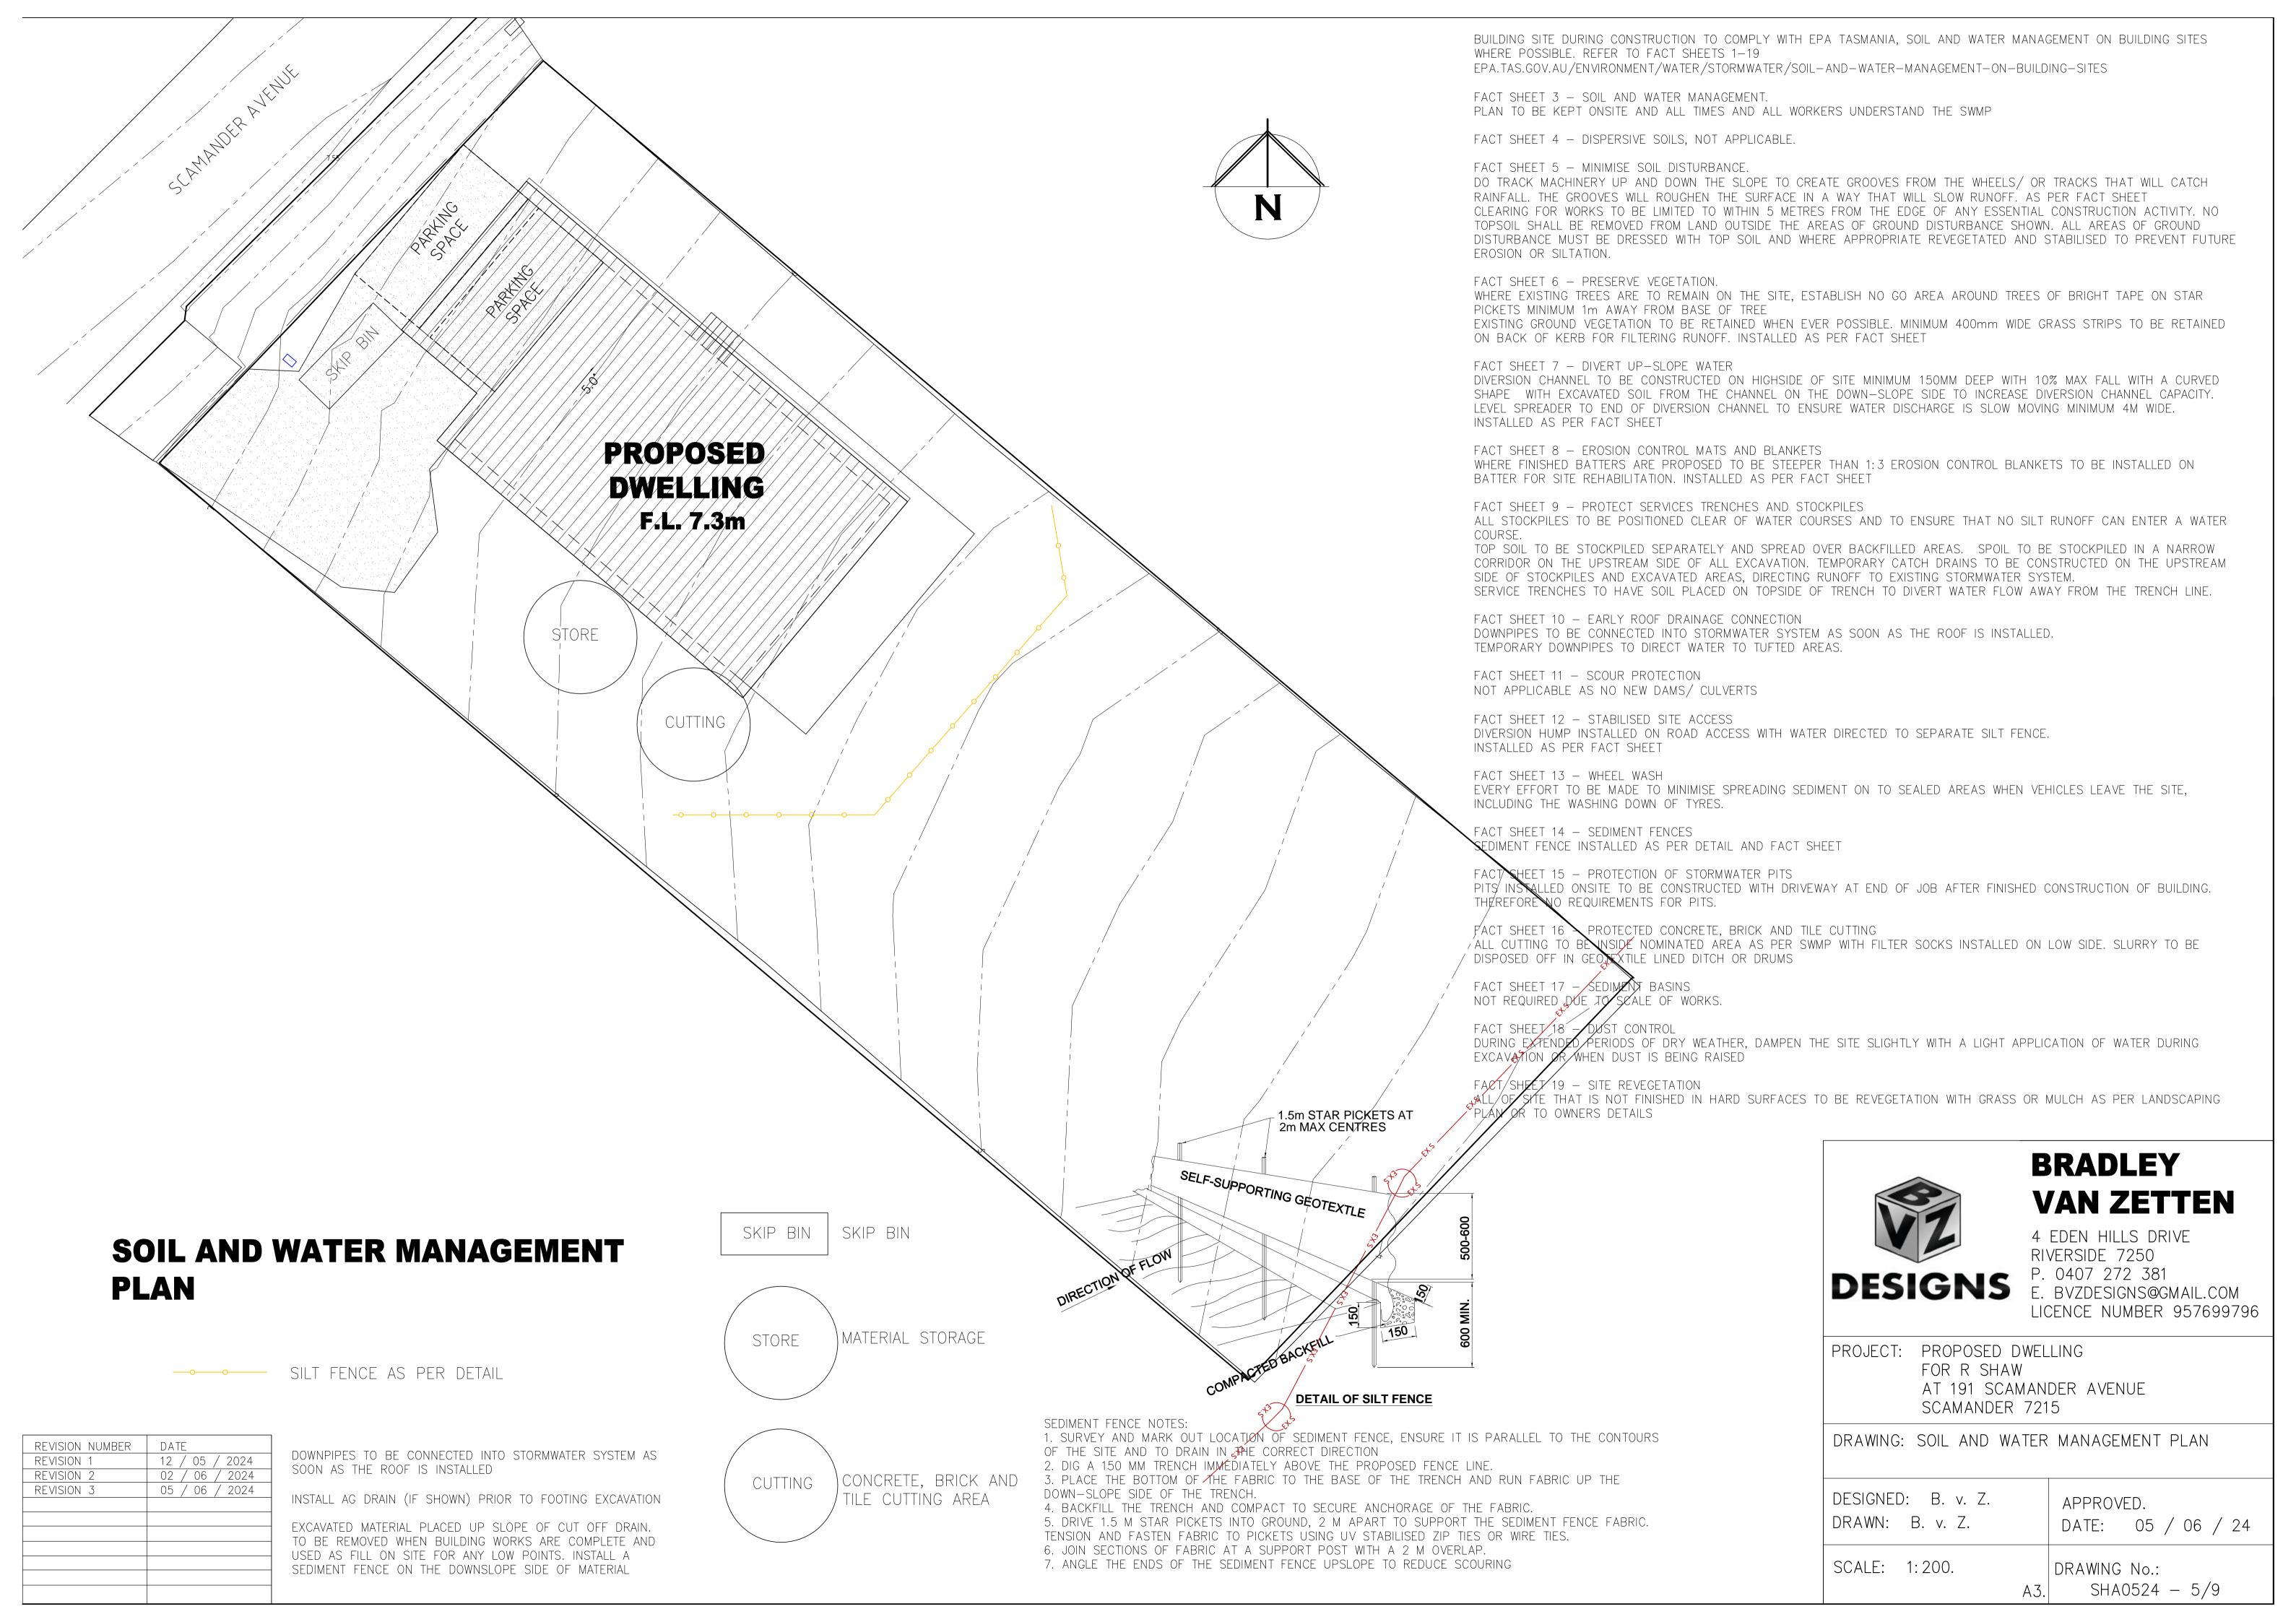

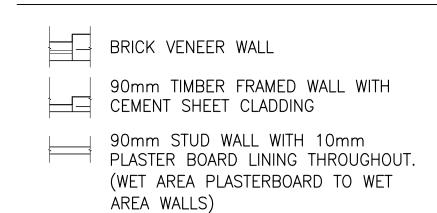

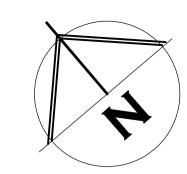

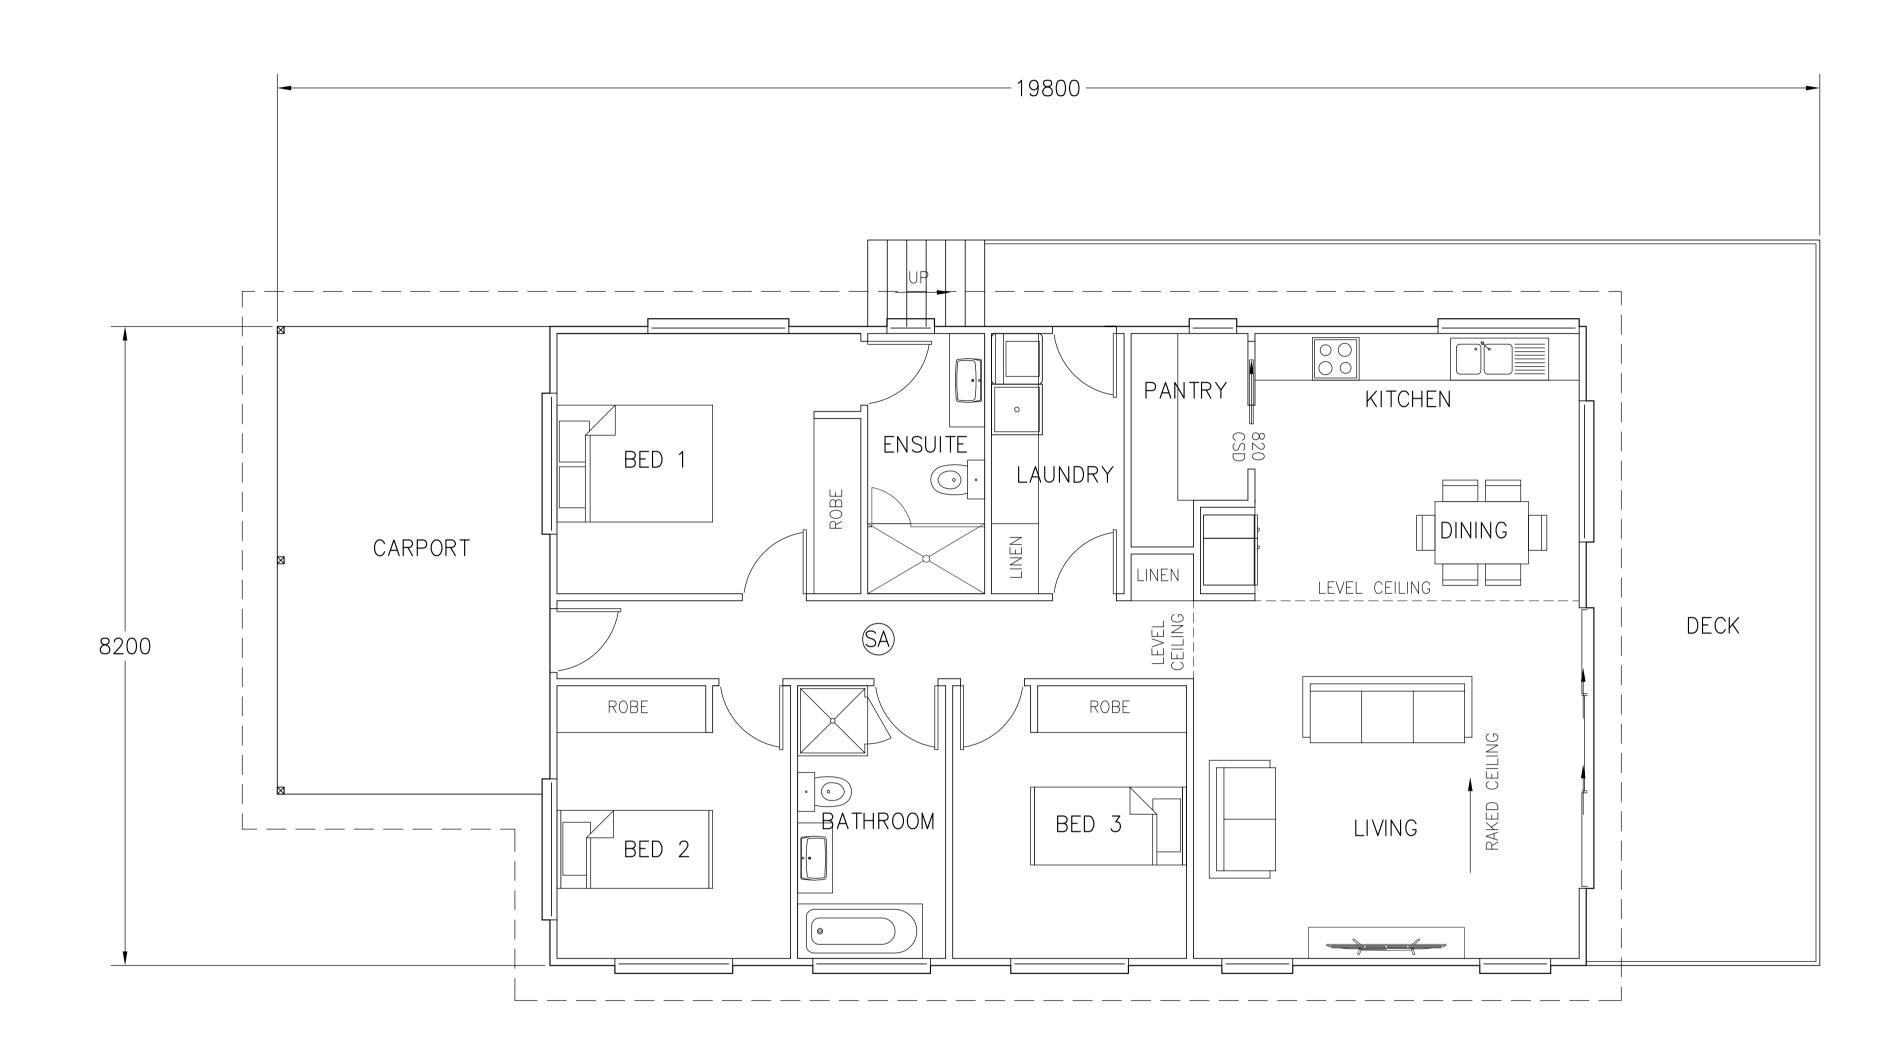

SA - 240V HARD WIRED SMOKE ALARMS
INSTALLED IN ACCORDANCE WITH NCC9.5 TO
COMPLY WITH AS3786, BE CONNECTED TO MAINS
POWER AND INTERCONNECTED WHERE THERE IS
MORE THAN ONE ALARM



## BRADLEY VAN ZETTEN

4 EDEN HILLS DRIVE RIVERSIDE 7250 P. 0407 272 381 E. BVZDESIGNS@GMAIL.COM LICENCE NUMBER 957699796

PROJECT: PROPOSED DWELLING FOR R SHAW

AT 191 SCAMANDER AVENUE

SCAMANDER 7215

DRAWING: FLOOR PLAN

12 / 05 / 2024 02 / 06 / 2024 05 / 06 / 2024 DESIGNED: B. v. Z. DRAWN: B. v. Z.

REVISION NUMBER DATE

REVISION 1

REVISION 2

REVISION 3

APPROVED.
DATE: 05 / 06 / 24

SCALE: 1:100. DRAWING No.: A3. SHA0524 - 6/9

AREA TABLE

SQUARE METER BUILDING SQUARES

FLOOR AREA 109.6 11.8


CARPORT AREA 21.0 2.3


DECK AREA 37.0 4.0

TOTAL AREA 167.6 18.0

#### **FLOOR PLAN**

BRICK VENEER — DIMENSIONS AND AREA TO OUTSIDE CLADDING CLAD FRAME — DIMENSIONS AND AREA TO OUTSIDE OF TIMBER FRAMING. CLADDING IN ADDITION TO DIMENSIONS ALL INTERNAL DOORS ARE 820mm UNLESS OTHERWISE NOTED

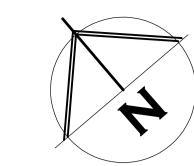

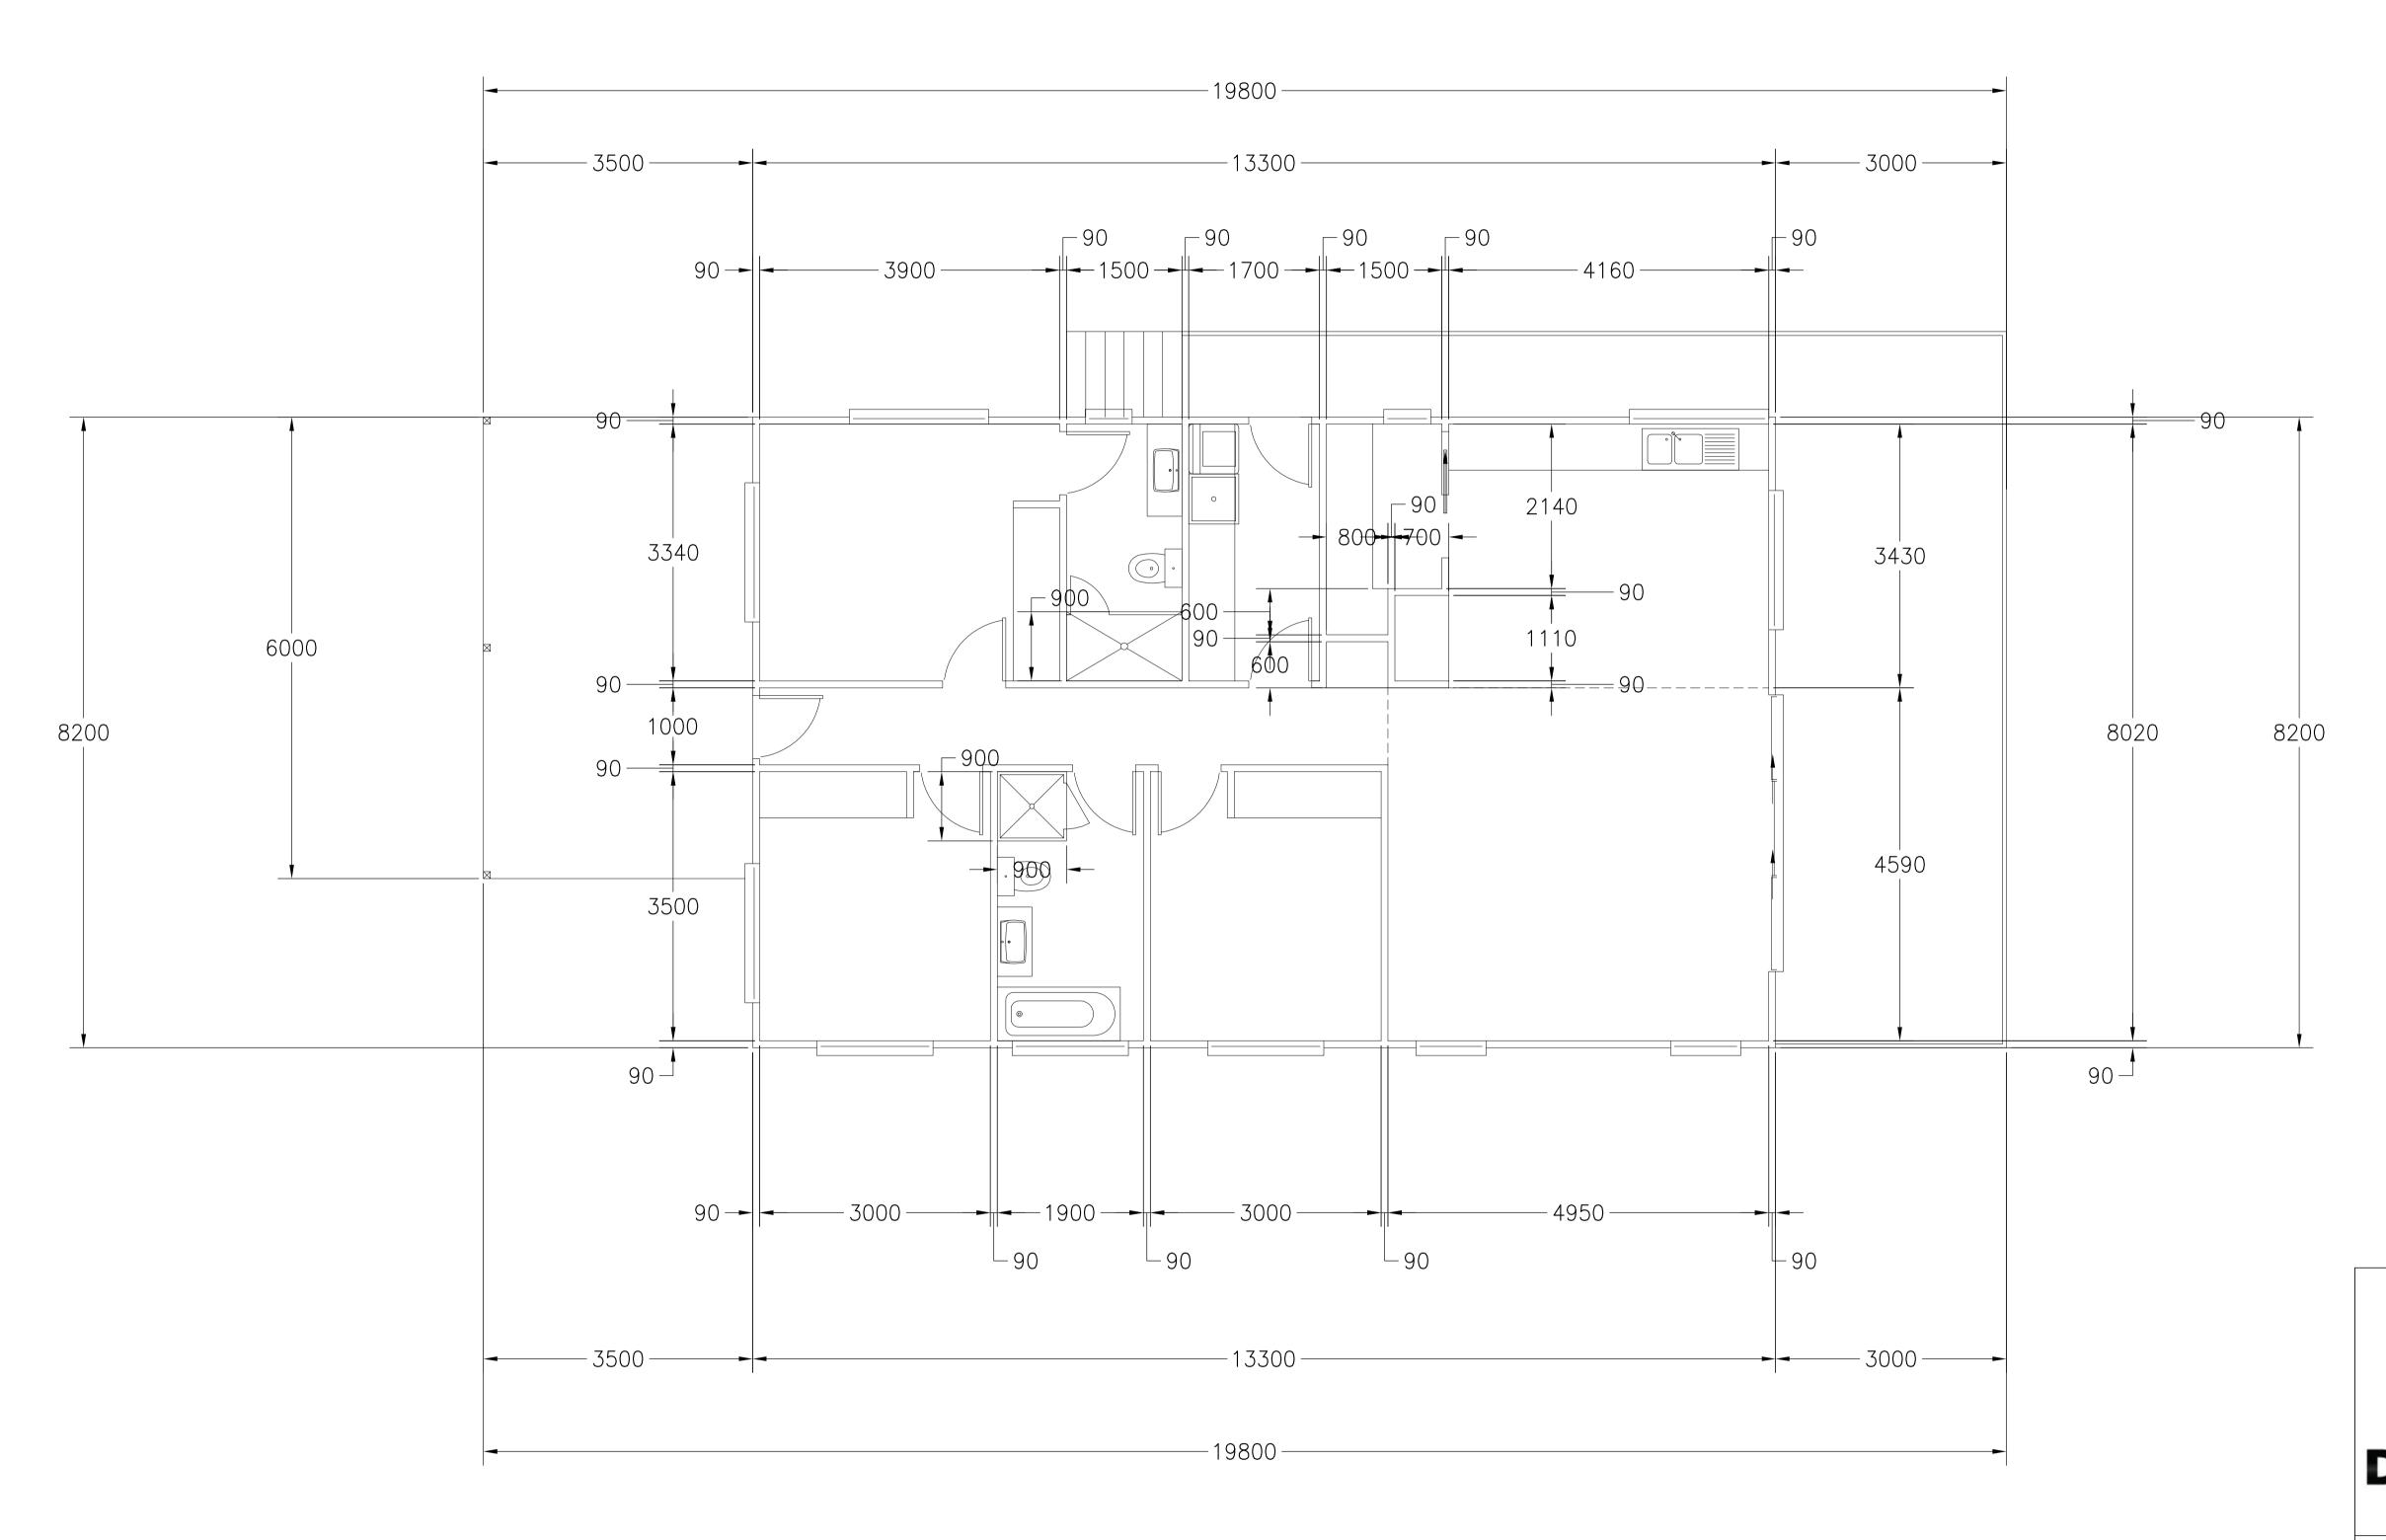

#### FLOOR PLAN WITH DIMENSIONS

REVISION NUMBER	DATE	DRA
REVISION 1	12 / 05 / 2024	
REVISION 2	02 / 06 / 2024	
REVISION 3	05 / 06 / 2024	DESI
		l neai
		DRA
		SCA

# BRADLEY VAN ZETTEN 4 EDEN HILLS DRIVE

4 EDEN HILLS DRIVE RIVERSIDE 7250 P. 0407 272 381 E. BVZDESIGNS@GMAIL.COM LICENCE NUMBER 957699796

PROJECT: PROPOSED DWELLING
FOR R SHAW
AT 191 SCAMANDER AVENUE
SCAMANDER 7215


DRAWING: FLOOR PLAN WITH DIMENSIONS


DESIGNED: B. v. Z. DRAWN: B. v. Z.


APPROVED.
DATE: 05 / 06 / 24

ALE: 1:100. DRAWING No.:

DRAWING No.: A3. SHA0524 - 7/9

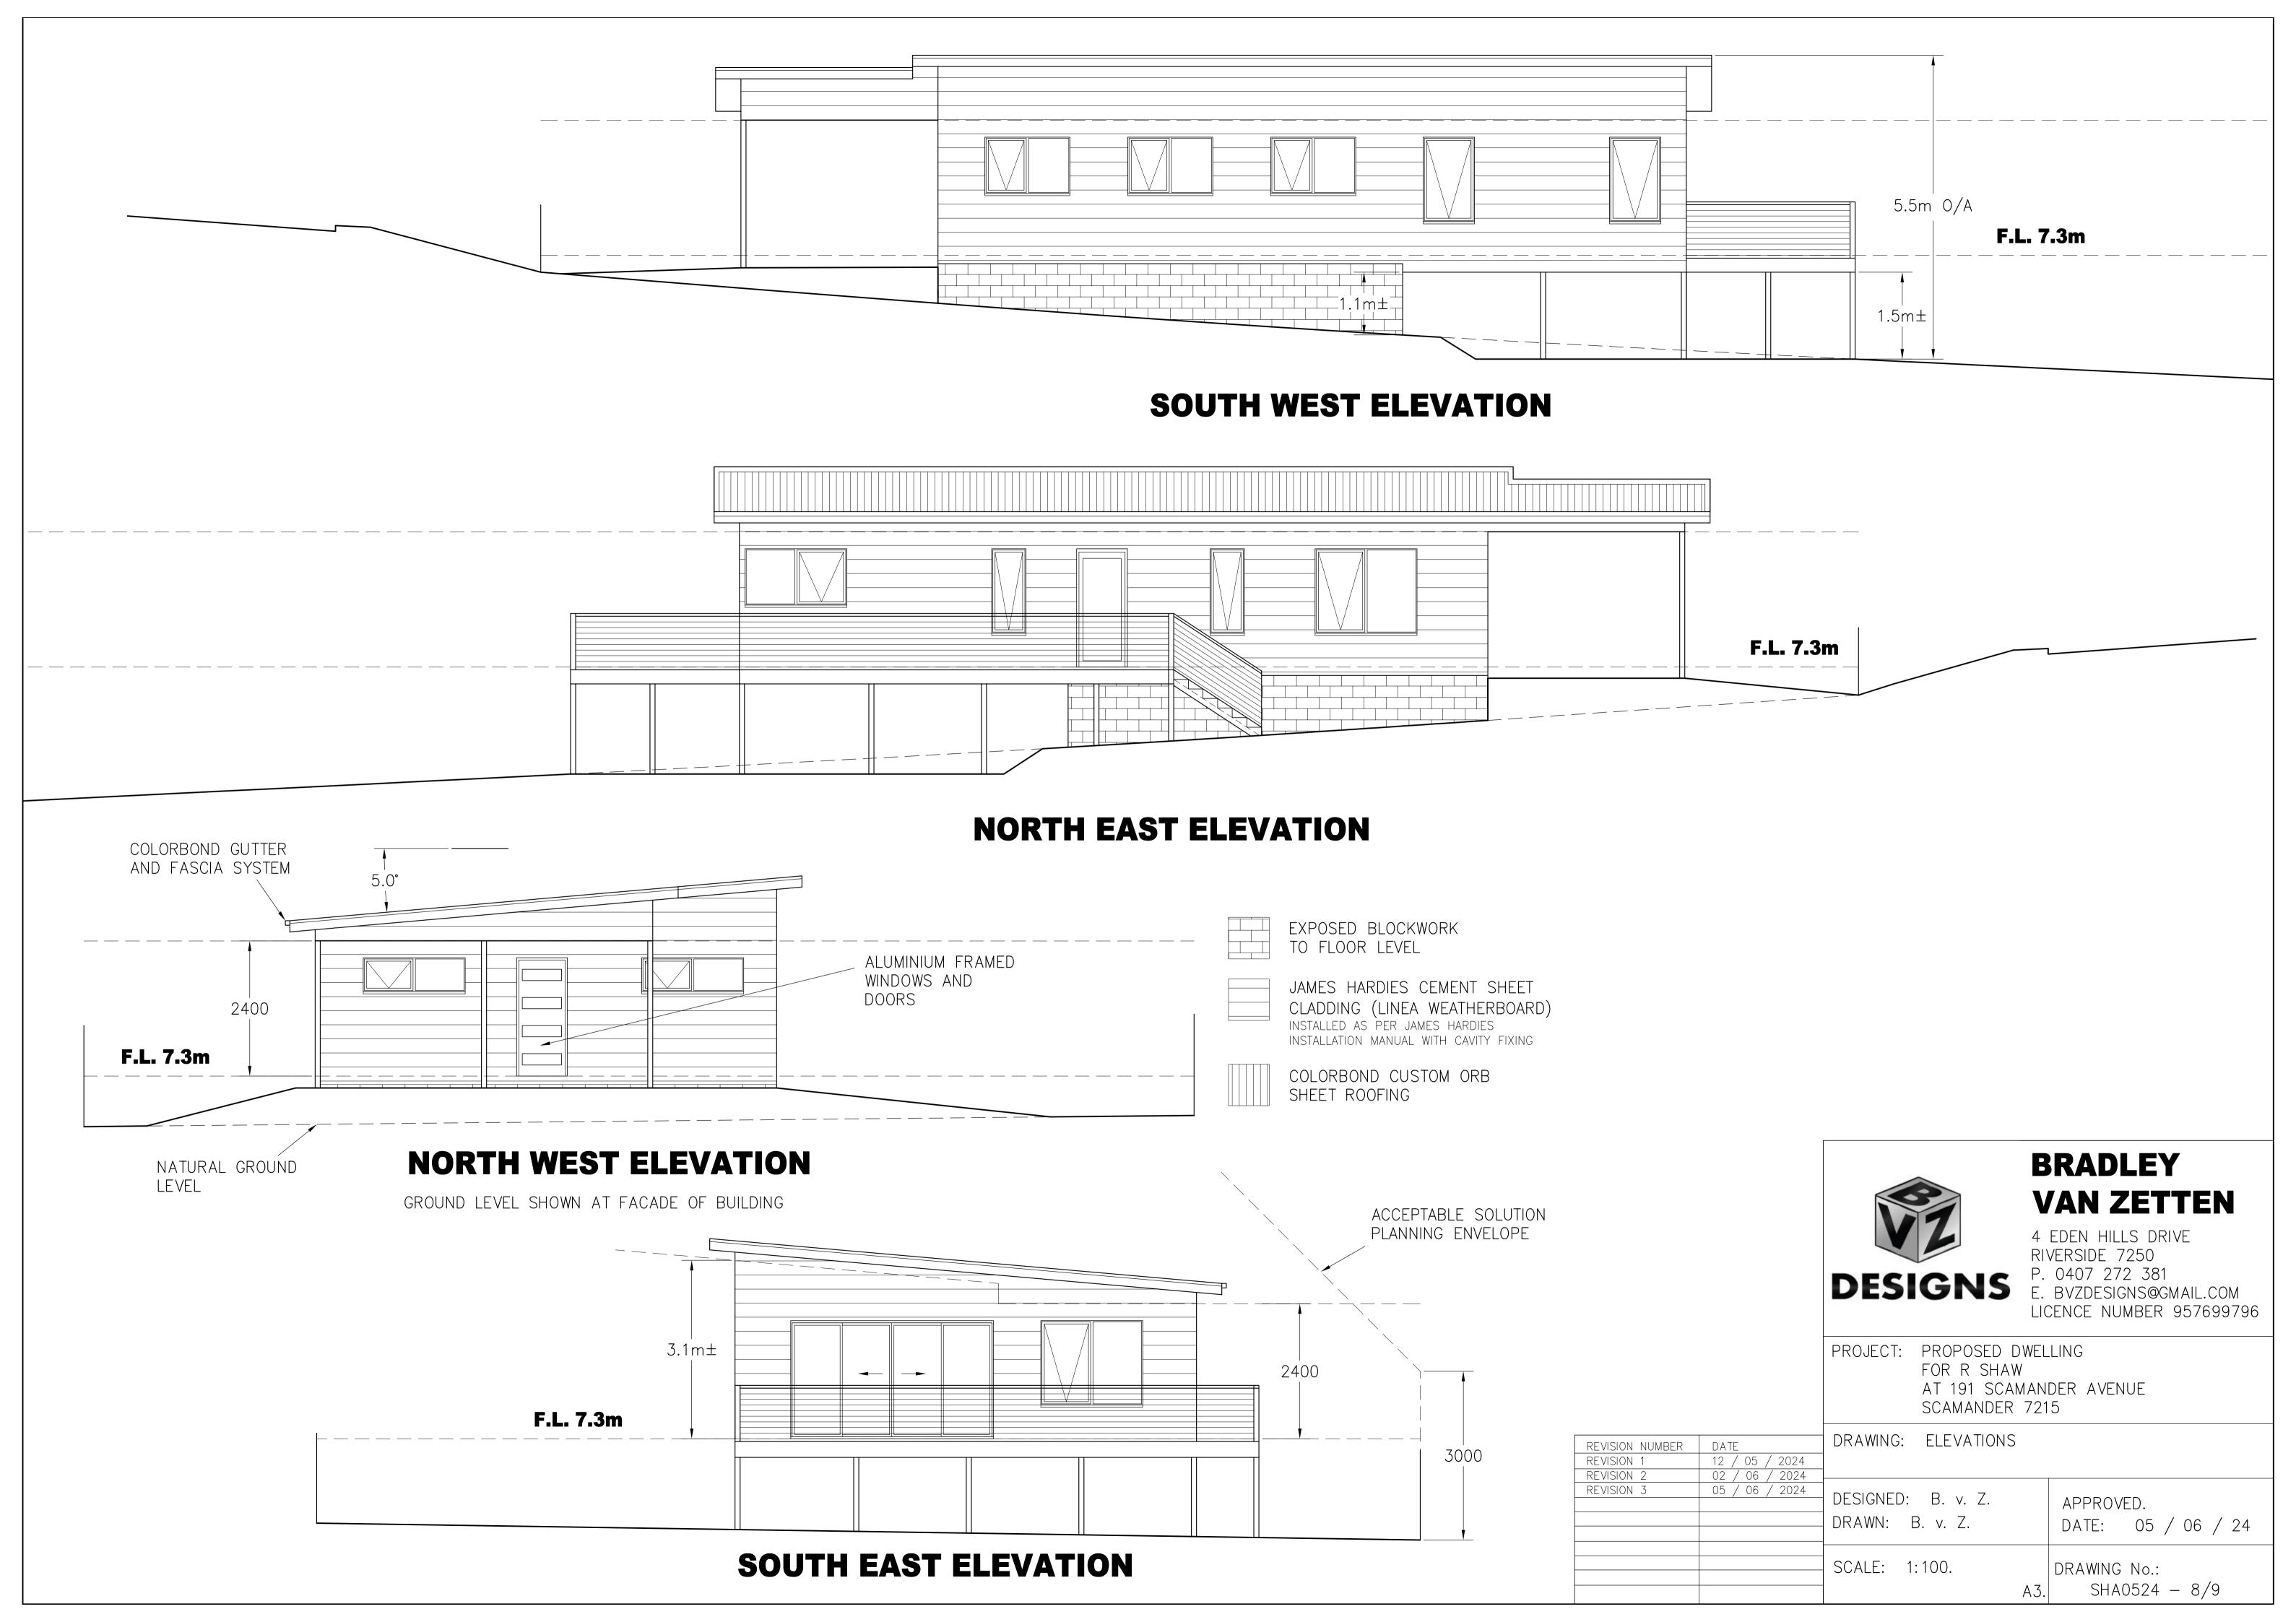

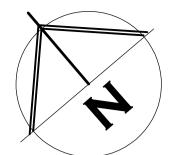

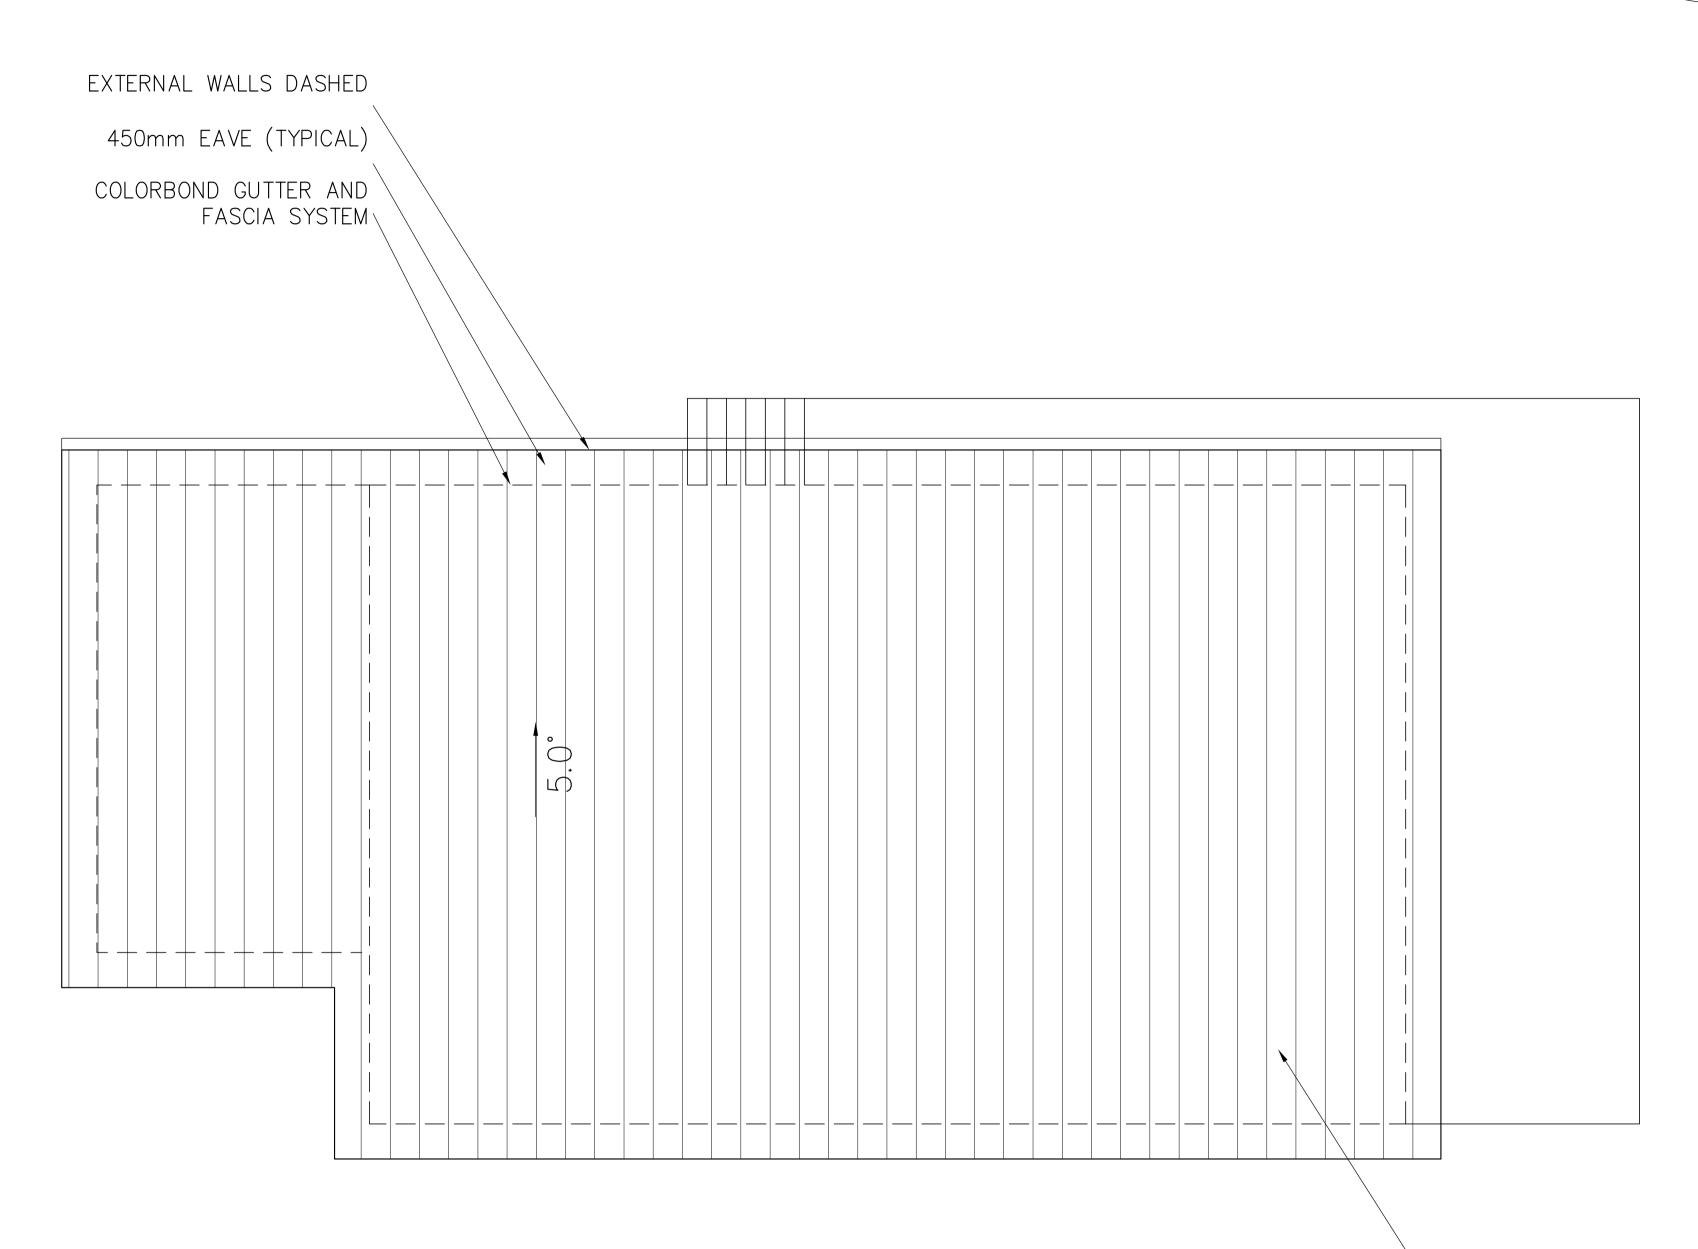

**ROOF PLAN** 

SHEET ROOF 75x38mm HARD WOOD OR 70x35mm MGP12 BATTENS AT 900mm MAX 900mm CRS AND SPAN.

RANGEHOOD AND BATHROOM EXTRACTION FANS DUCTED TO EAVE/WALL VENT

COLORBOND CUSTOM ORB ROOF SHEETING AT 5.0°. ONE AND A HALF CORRUGATION SIDE LAP (TYPICAL). FIXED AT SIDE LAPS. 3 FIXINGS FOR INTÉRNAL SPANS AND 5 FOR END SPANS. FIXED WITH ROOFZIPS M6-11x50mm FOR SOFTWOOD AND STEEL 0.55-1.0mm BMT BATTENS 12-14x35 METAL TEK 1.0-3.0mm BMT

STEEL BATTENS

12-11x50mm FOR HARDWOOD

ROOF CLADDING TO COMPLY WITH NCC PART 7.1-7.5

GUTTERS AND DOWNPIPES INSTALLED AS PER NCC PART 7.4 GUTTER MUST BE INSTALLED WITH A FALL NOT LESS THAN

• 1:500 FOR EAVES GUTTERS, UNLESS FIXED TO METAL FASCIAS

WHERE HIGH FRONTED GUTTERS ARE INSTALLED, PROVISION MUST BE MADE TO AVOID ANY OVERFLOW BACK INTO THE ROOF OR BUILDING STRUCTURE BY INCORPORATING OVERFLOW MEASURERS OR THE LIKE

DOWNPIPES MUST--

(A)NOT SERVE MORE THAN 12 M OF GUTTER LENGTH FOR EACH DOWNPIPE; AND

(B)BE LOCATED AS CLOSE AS POSSIBLE TO VALLEY GUTTERS;

(C)BE SELECTED IN ACCORDANCE WITH THE APPROPRIATE EAVES GÚTTER SECTION AS SHOWN IN TABLE 7.4.3A, TABLE 7.4.3B AND TABLE 7.4.3C.

FOR ROOF CATCHMENTS UP TO 50SQ/M PER DOWNPIPE MEDIUM RECTANGULAR GUTTERS OR 115MM 'D' GUTTERS MAY BE USED WITH 900MM DOWNPIPES

EAVE AND GUTTER OVERFLOW MEASURE TO BE INSTALLED FOR 1% ANNUAL EXCEEDANCE PROBABILITY

BOX GUTTERS AS PER AS3500.3

7.4.6 ACCEPTABLE CONTINUOUS OVERFLOW MEASURE

(1) FOR A FRONT FACE SLOTTED GUTTER WITH-

A MINIMUM SLOT OPENING AREA OF 1200 MM2 (A) PER METRE OF GUTTER; AND

(a) THE LOWER EDGE OF THE SLOTS INSTALLED A MINIMUM OF 25 MM BELOW THE TOP OF THE FASCIA,

THE ACCEPTABLE OVERFLOW CAPACITY MUST BE 0.5 L/S/M, CONSTRUCTED IN ACCORDANCE WITH FIGURE 7.4.6A.

(2) FOR A CONTROLLED BACK GAP WITH—

(a) A PERMANENT MINIMUM 10 MM SPACER INSTALLED BETWEEN THE GÚTTER BACK AND THE FASCIA; AND

(b) ONE SPACER PER BRACKET, WITH THE SPACER NOT MORE THAN 50 MM WIDE; AND

- (c) THE BACK OF THE GUTTER INSTALLED A MINIMUM OF 10 MM BELOW THE TOP OF THE FASCIA,
- THE ACCEPTABLE OVERFLOW CAPACITY MUST BE 1.5 L/S/M, CONSTRUCTED IN ACCORDANCE WITH FIGURE 7.4.6B.
- (3) FOR THE CONTROLLED BACK GAP OPTION, THE SPACER CAN BE À PROPRIETARY CLIP OR BRACKET THAT PROVIDES THE REQUIRED OFFSET OF
- THE GUTTER FROM THE FASCIA.



#### **BRADLEY VAN ZETTEN**

4 EDEN HILLS DRIVE RIVERSIDE 7250 P. 0407 272 381 DESIGNS E. BVZDESIGNS@GMAIL.COM LICENCE NUMBER 957699796

PROJECT: PROPOSED DWELLING FOR R SHAW

AT 191 SCAMANDER AVENUE SCAMANDER 7215

DRAWING: ROOF PLAN

REVISION 2 02 / 06 / 2024 REVISION 3 05 / 06 / 2024 DESIGNED: B. v. Z. DRAWN: B. v. Z.

12 / 05 / 2024

REVISION NUMBER DATE

REVISION 1

APPROVED.

DATE: 05 / 06 / 24

SCALE: 1:100. DRAWING No.:

A3. SHA0524 - 9/9



#### **BRADLEY VAN ZETTEN**

4 EDEN HILLS DRIVE

**RIVERSIDE 7250** 

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LICENCE NUMBER 957699796

Reply to the planning scheme for 191 Scamander Avenue Scamander 7215

8.4.2 Setbacks and building envelope for all dwellings

#### **P2**

A garage or carport for a dwelling must have a setback from a primary frontage that is compatible with the setbacks of existing garages or carports in the street, having regard to any topographical constraints.

P2 – While the acceptable solution requires garages to be set back 5.5m from the front boundary. The intent of this is to allow a car to be parked in front of the garage door and not have the rear of the vehicle extend out past the title boundary. This all assumes the garage door to be parallel to the street boundary, so the parking is perpendicular.

In this case, the parking is parallel to the street boundary, so there will not be parking issues, as detailed above. Therefore, the carport will be more similar to if it was any other part of the building. The carport is also open on three sides, so visually from the street, it will only be the posts and roof that are visible, with the closest part of the solid wall being the bed 1 corner of the house, which is 6.5m from the street so its 2m greater than the acceptable solution setback.

There are several other properties with variations to the front setback also located on Scamander Ave.

53 Scamander Ave – This is nearly exactly the same, with the carport extending in front of the dwelling approximately 2.5-3m setback to Scamander Ave.

87 Scamander Ave - Has a carport attached to the shed quite close to the boundary. Due to the tree cover, a setback was not available, but it is within 5.5m

149 Scamander Ave – This has a veranda setback 3-3.5m from the front boundary. While it's a veranda not a carport, visually from the street, the appearance is exactly the same with posts and a roof.

177 Scamander Ave – This appears to be a much newer build, with the garage door being located within the acceptable solution of 5.5m from the front boundary. This is the point raised above, on what I believe is the main intent of this requirement, as in the street view, it's visible where cars are parked and protruding off the property.

**Kind Regards** 

**Bradley Van Zetten**