32-34 Georges Bay Esplanade St Helens Tasmania 7216 T: 03 6376 7900 ABN 96 017 131 248



Development Applications

Notice is hereby given under Section 57(3) of the *Land Use Planning & Approvals Act 1993* that an application has been made to the Break O' Day Council for a permit for the use or development of land as follows:

DA Number	DA 2024 / 00025
Applicant	Tasmanian Manufactured Housing Pty Ltd
Proposal	Manufacturing & Processing - Addition to Workshop
Location	25463 Tasman Highway, St Helens

Plans and documents can be inspected at the Council Office by appointment, 32 – 34 Georges Bay Esplanade, St Helens during normal office hours or online at <u>www.bodc.tas.gov.au</u>.

Representations must be submitted in writing to the General Manager, Break O'Day Council, 32 -34 Georges Bay Esplanade, St Helens 7216 or emailed to <u>admin@bodc.tas.gov.au</u>, and referenced with the Application Number in accordance with section 57(5) of the abovementioned Act during the fourteen (14) day advertised period commencing on Saturday 22nd June, 2024 **until 5pm Friday 5th July, 2024.**

John Brown GENERAL MANAGER







P: 0421 745 095
E: info@alldraw.com.au
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Licence # 911670743


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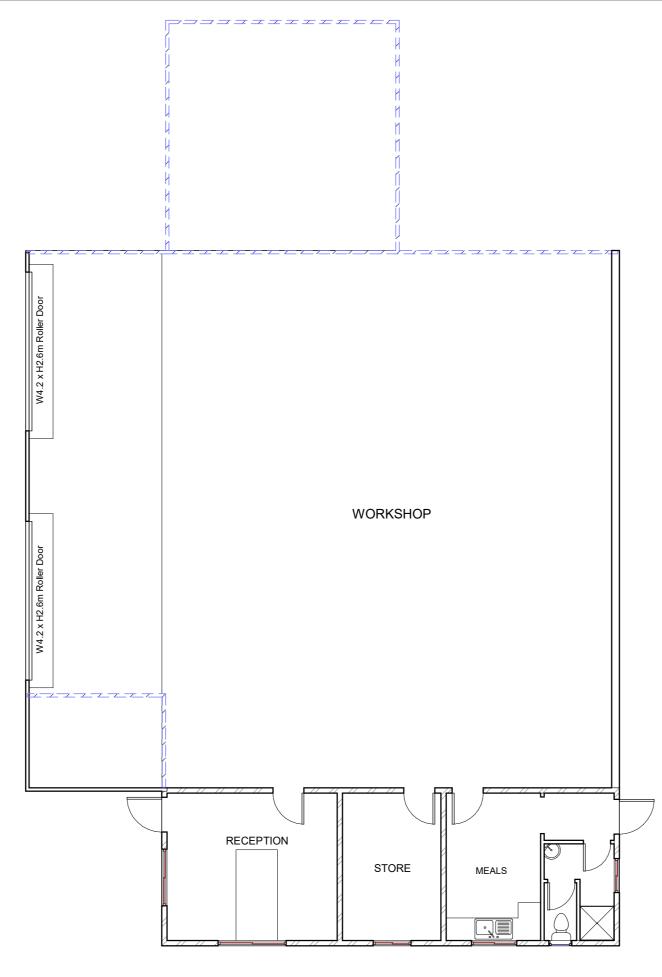
Work Shed Addition 25463 Tasman Hwy, St.Helens



ITE AREA PLAN				
T	Project number	016		
	Date	18/06/2024	P1	
	Drawn by	JK		
$\mathbf{+}$	Checked by	TF	Scale	

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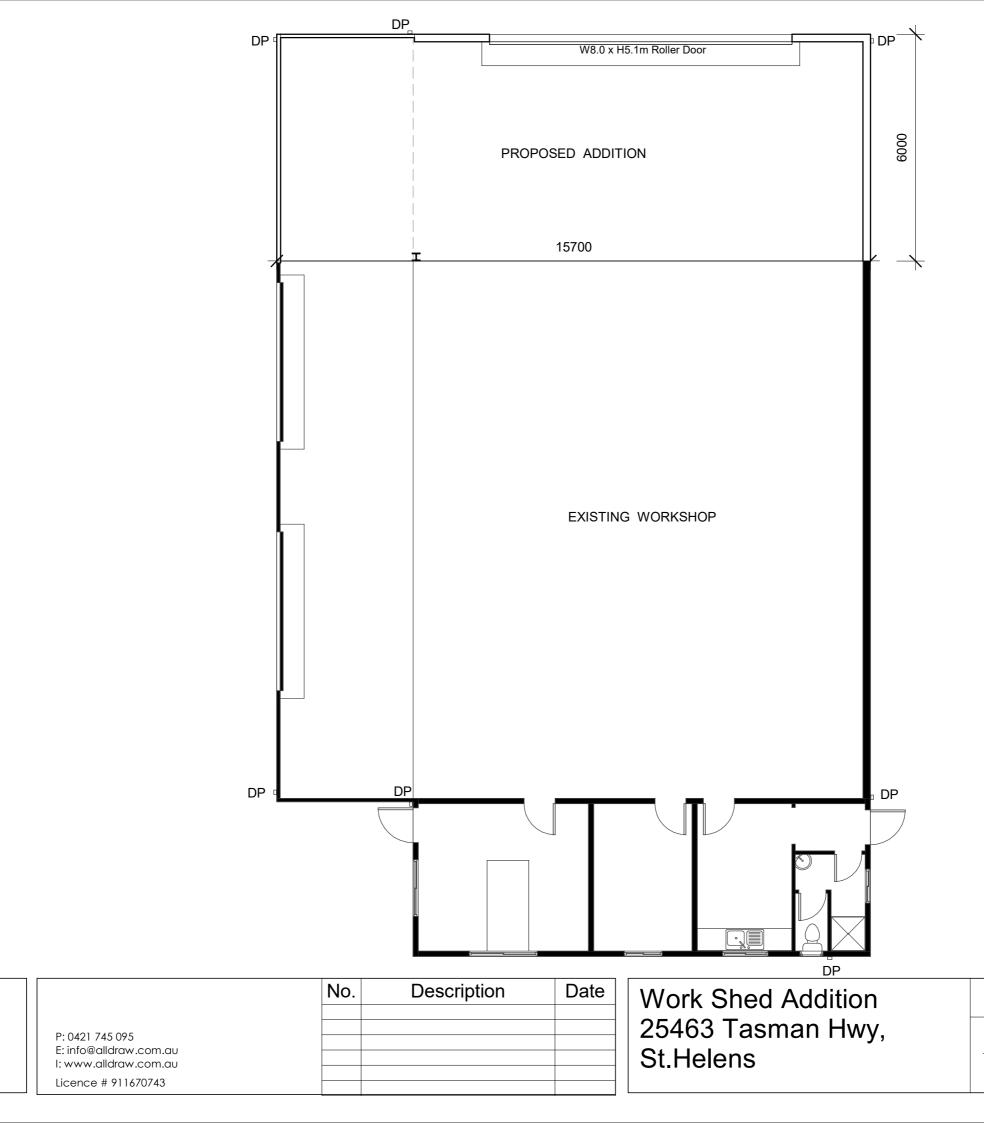
No.	Description	Date

Work Shed Addition 25463 Tasman Hwy, St.Helens

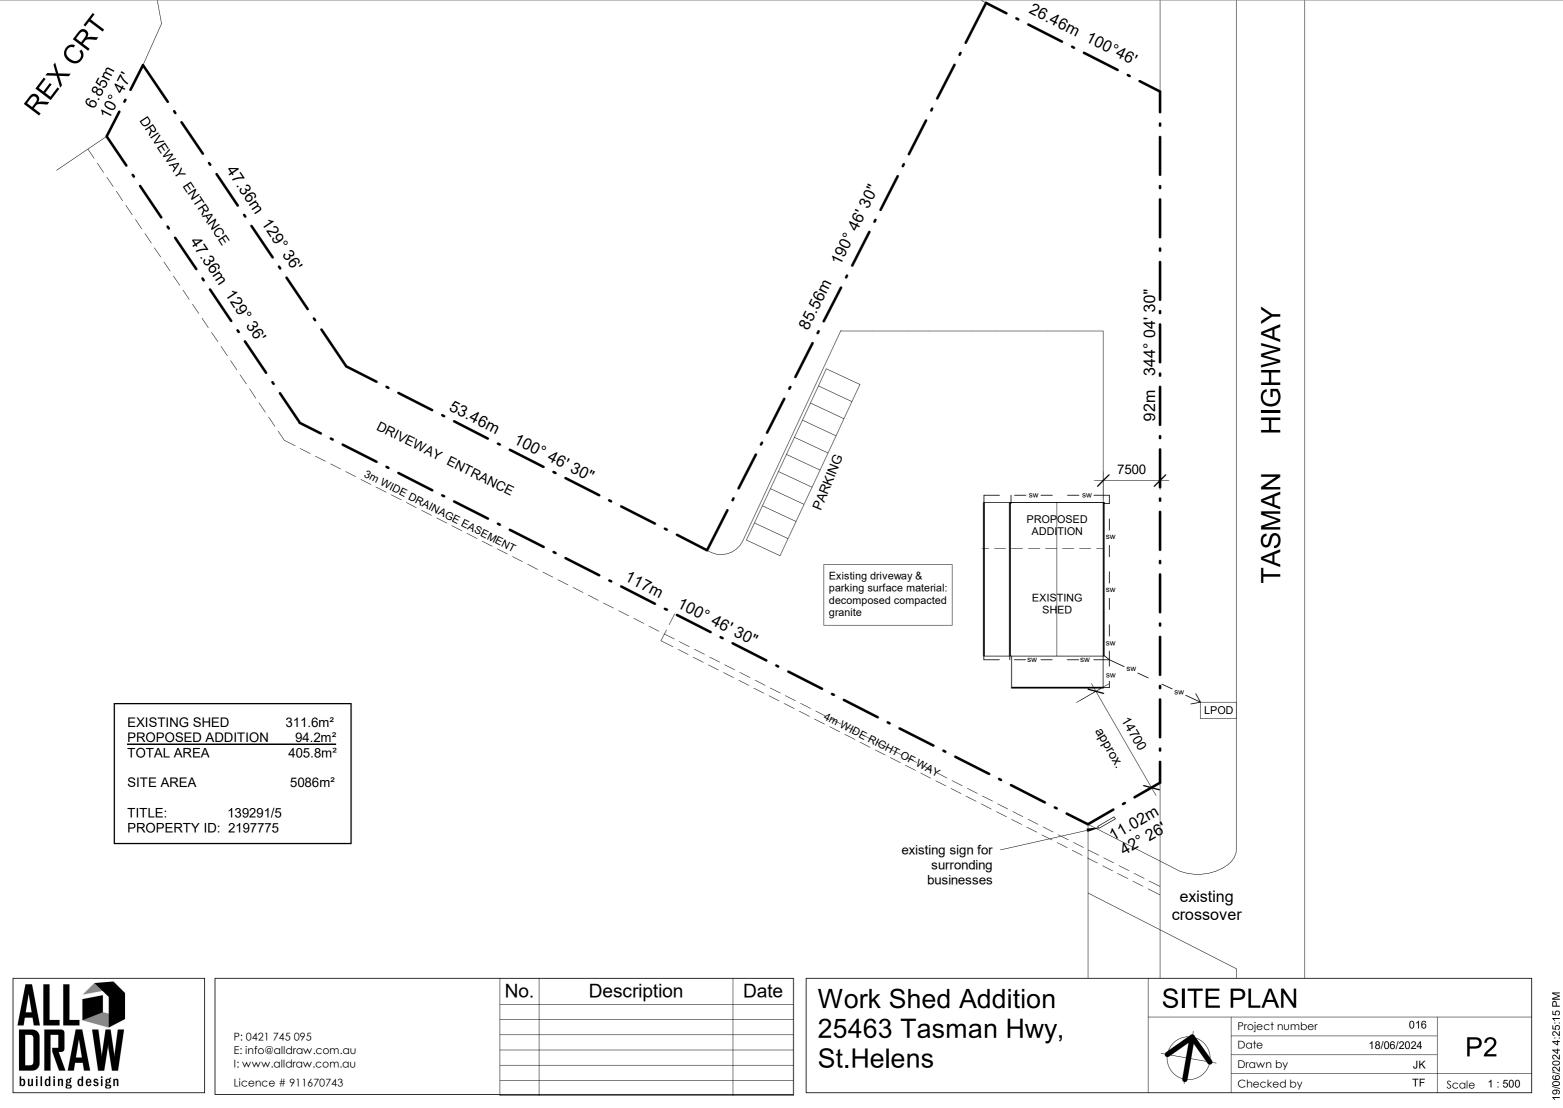

TO BE REMOVED

XISTING FLOOR PLAN					
1	Project number	016			
	Date	18/06/2024	P	3	
	Drawn by	JK	•	•	
\mathbf{P}	Checked by	TF	Scale	1 : 100	



ALL

building design




PROPOSED FLOOR PLAN 016 Project number P4 18/06/2024 Date Drawn by JK

Checked by

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TF

Scale 1:100

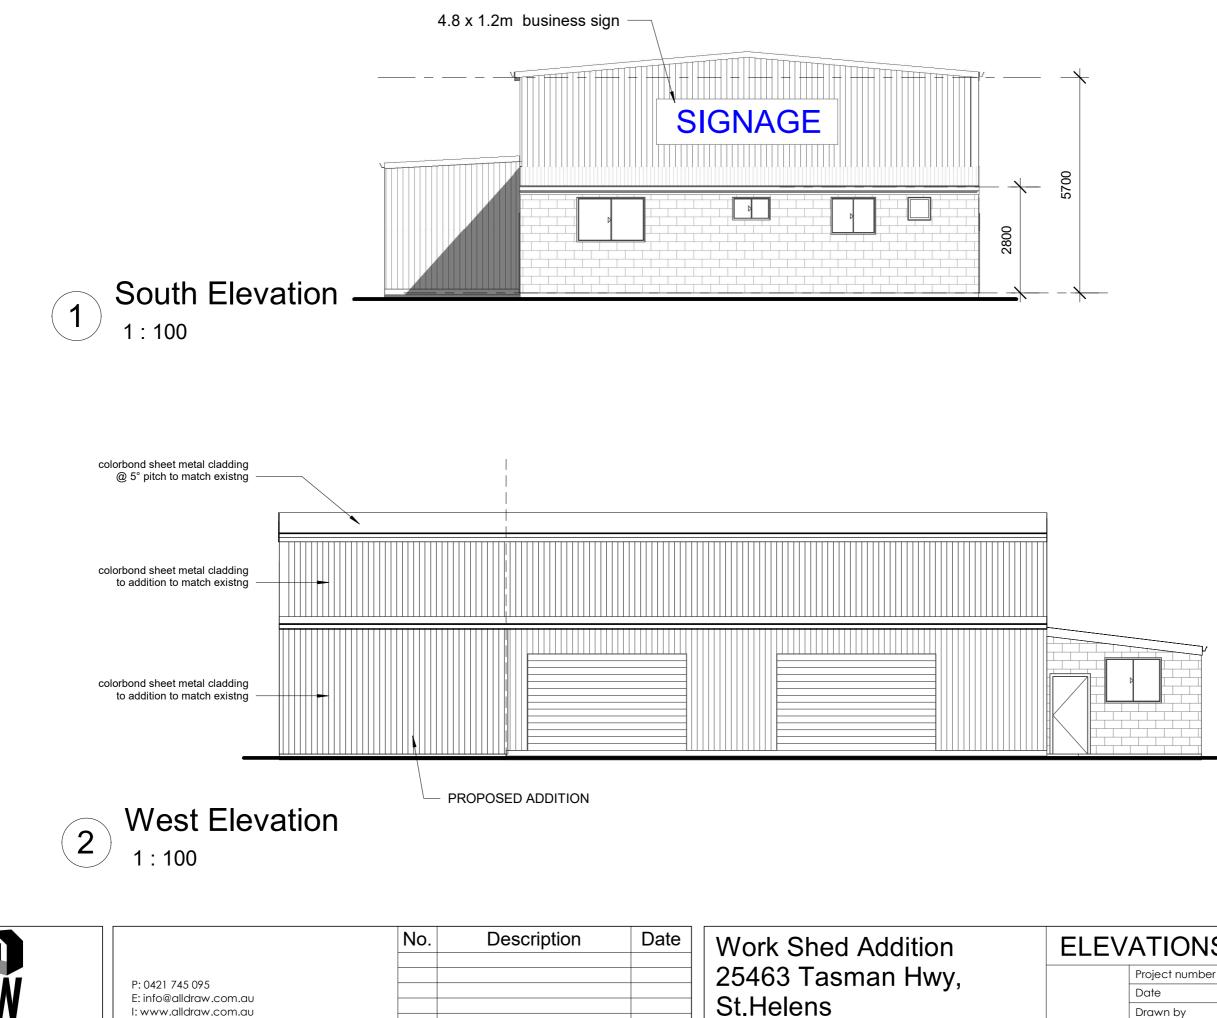


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building design

l:www.alldraw.com.au


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	Date	18/06/2024	P5	
	Drawn by	JK		/202
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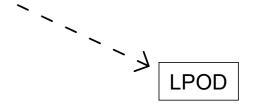


ALL		No.	Description	Date	Work Shed Addition	E
<b>DRAW</b> building design	P: 0421 745 095 E: info@alldraw.com.au I: www.alldraw.com.au Licence # 911670743				25463 Tasman Hwy, St.Helens	


LEV	ATIONS			
	Project number	016		
	Date	18/06/2024	P	6
	Drawn by	JK	•	•
	Checked by	TF	Scale	1 : 100

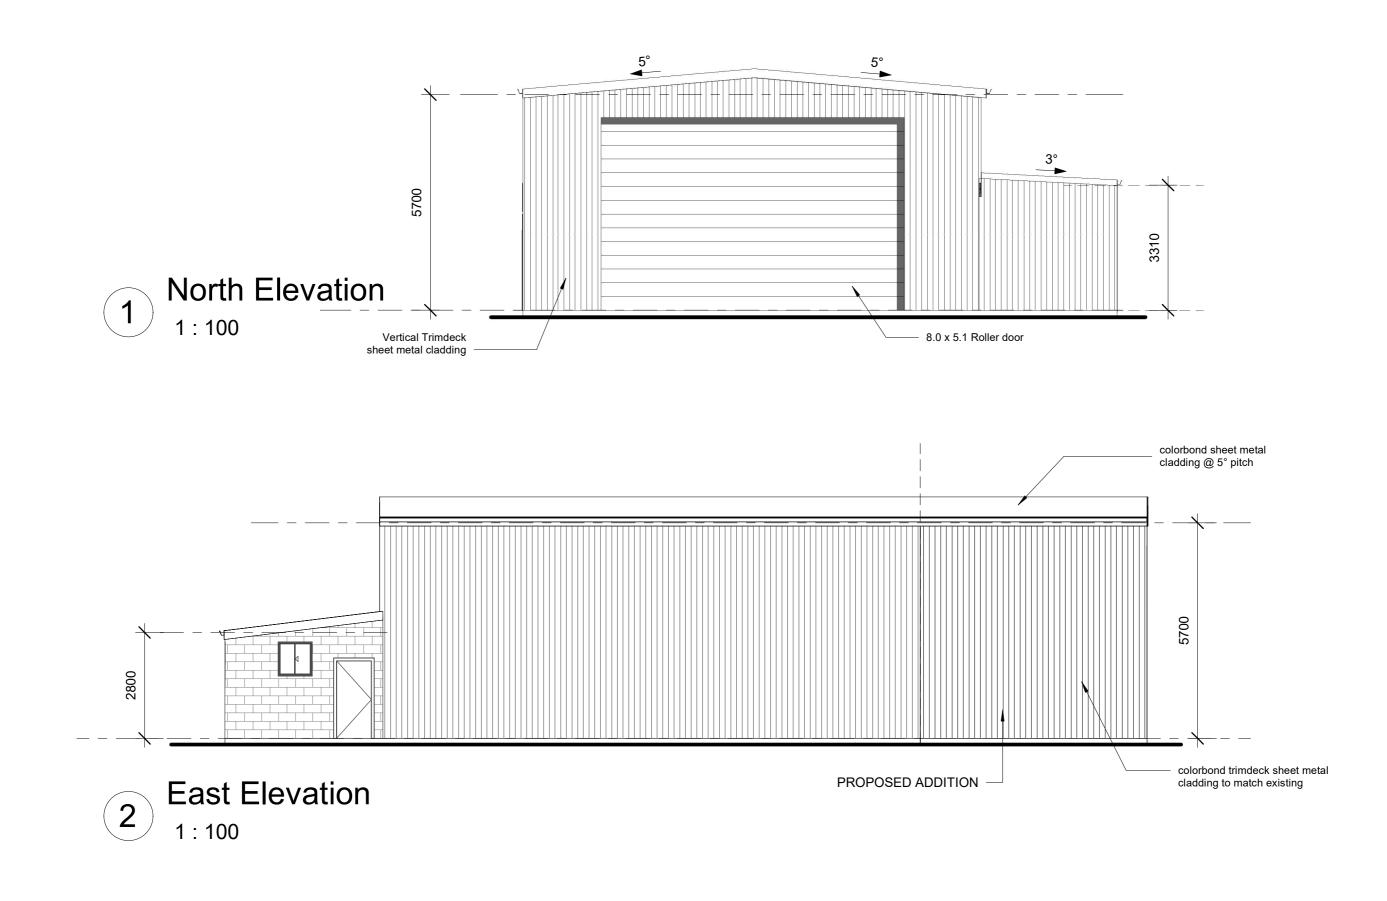

corugated sheet metal roof cladding @ 5° pitch to match existing

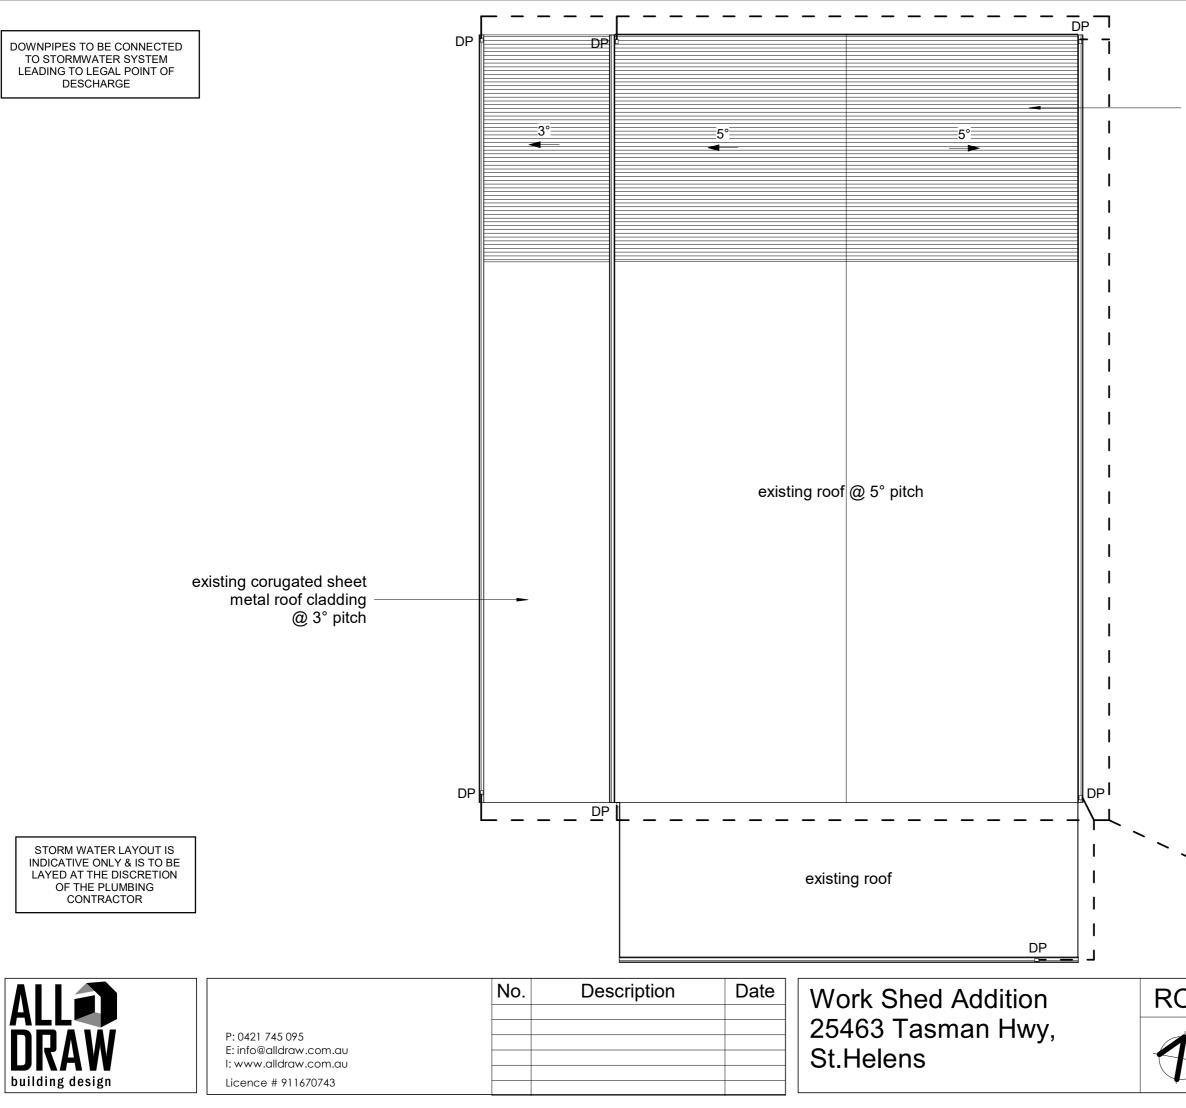

JOF	F PLAN			6 PM
1	Project number	016		:25:1
	Date	18/06/2024	P7	4
	Drawn by	JK	• •	/202
	Checked by	TF	Scale 1:10	9/06/2024
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DA 2024 / 00025
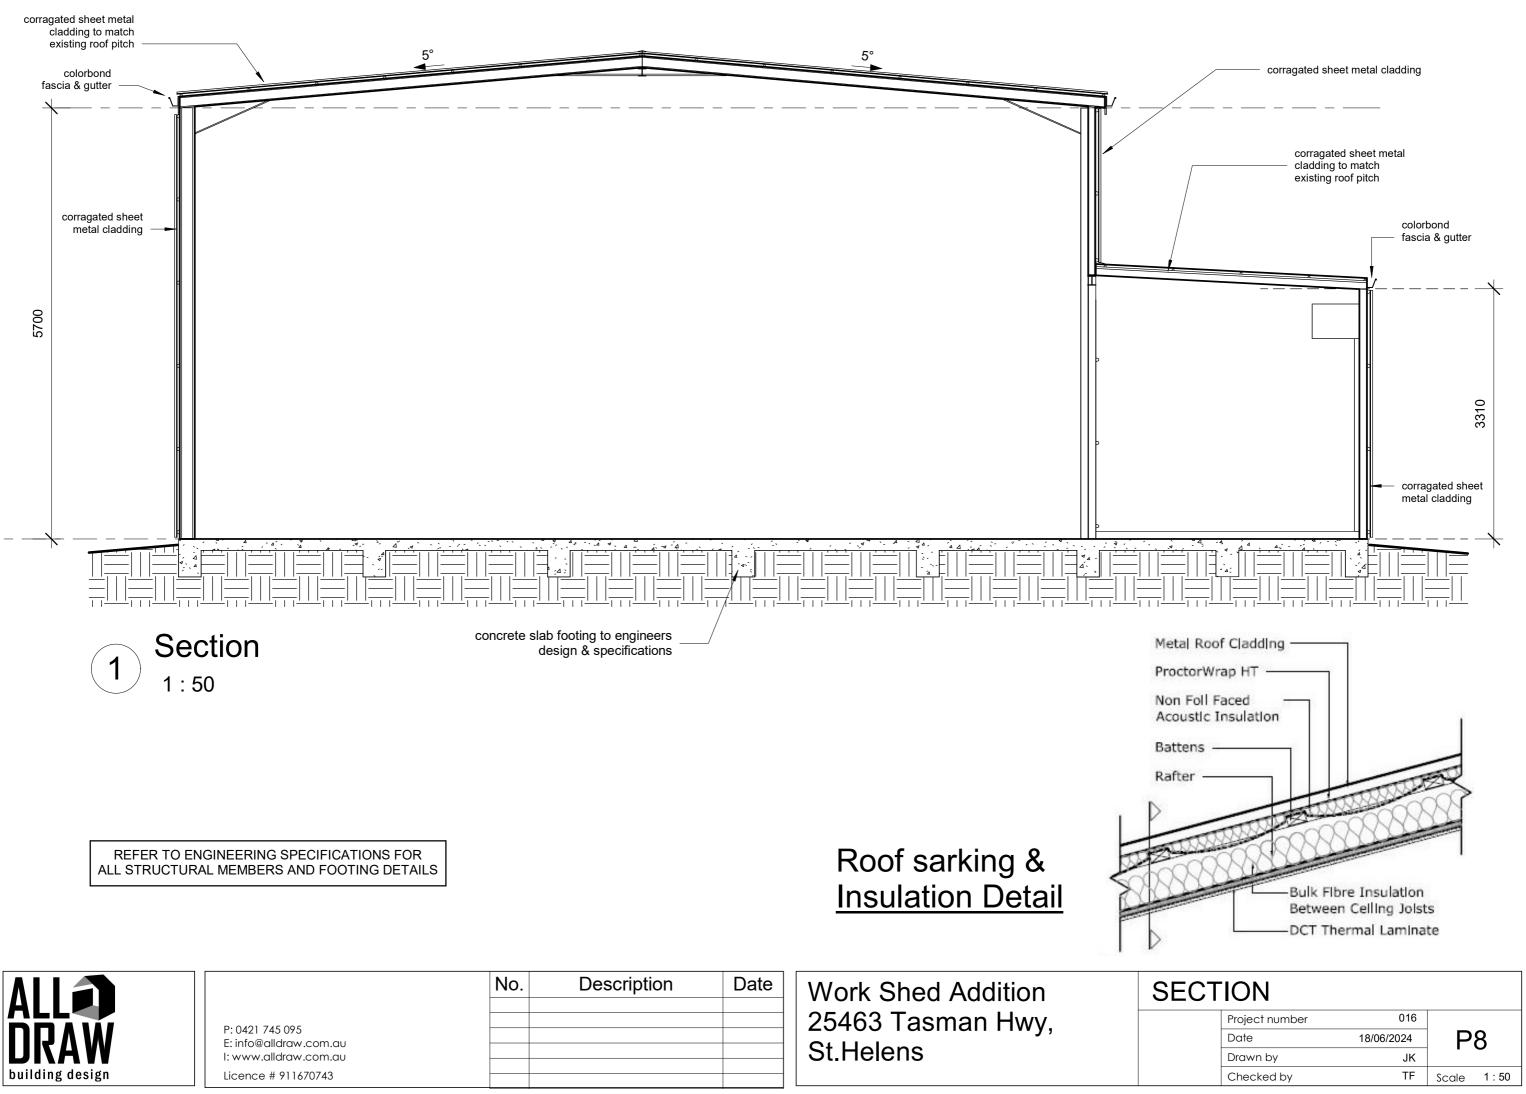
# **Planning Scheme Response**

То

## THE TASMANIAN PLANNING SCHEME

# FOR 25463 Tasman Highway, St.Helens

PREPARED BY:

James Kreltszheim Building Designer All Draw Building Design

Proposal	Addition to existing workshop
Applicant (Owners)	TASMANIAN MANUFACTURED HOUSING PTY LTD
Location of Subject Site	25463 Tasman Highway, St.Helens 7216
Title Details	139291/5
Restrictions / Covenants	SP 139291 EASEMENTS in Schedule of Easements SP 139291 COVENANTS in Schedule of Easements SP 139291 FENCING COVENANT in Schedule of Easements SP52919 FENCING COVENANT in Schedule of Easements
Land Size	5086m²
Zoning	General Industrial

### SUMMARY

This report has been prepared in support of the Planning Permit Application DA 2024 / 00025 **25463 Tasman Highway, St. Helens**. The application seeks approval for an addition to an existing factory shed in the St. Helens industrial estate to enable the construction and maintenance of modular accommodation units.

# 19. General Industrial Zone

C1.0 Signs Code					
C1.6.1 Design & siting of signs	Met?	Acceptable Solutions A1	Met?	Comments	
Objective: a) Signage is well designed & sited; and (b) signs do not contribute to visual clutter or cause an unreasonable loss of visual amenity to the surrounding area.	Yes	A sign must: (a) be located within the applicable zone for the relevant sign type set out in Table C1.6;and (b) meet the sign standards for the relevant sign type set out in Table C1.6,	Yes	The proposed signage type is a 'Wall Sign' which complies with the applicable zone of 'General Industrial' See 'South Elevation' on page 5 of planning drawings.	
	Met?	Performance Criteria P1	Met?	Comments	
	Yes	<ul> <li>P1.1 A sign must: <ul> <li>(a) be located within an applicable zone for the relevant sign type as set out in Table C1.6; and</li> <li>(b) be compatible with the streetscape or landscape, having regard to:</li> <li>(i) the size and dimensions of the sign;</li> <li>(ii) the size and scale of the building upon which the sign is proposed;</li> <li>(iii) the amenity of surrounding properties;</li> <li>(iv) the repetition of messages or information;</li> <li>(v) the number and density of signs on the site and on adjacent properties; and</li> <li>(vi) the impact on the safe and efficient movement of vehicles and pedestrians. </li> <li>P1.2 If a roof sign, sky sign or billboard, the sign must: <ul> <li>(a) be located within the applicable zone for the relevant sign type in Table C1.6;</li> <li>(b) meet the sign standards for the relevant sign type in Table C1.6; and</li> <li>(c) not contribute to visual clutter or cause unreasonable loss of amenity to the surrounding area, having regard to:</li> <li>(i) the size and scale of the building upon which the sign is proposed;</li> <li>(iii) the amenity of surrounding properties;</li> <li>(iv) the repetition of messages or information;</li> <li>(v) the number and density of signs on the site and on adjacent properties; and</li> <li>(vi) the repetition of messages or information;</li> </ul> </li> </ul></li></ul>	Yes N/A	The proposed signage type is a 'Wall Sign' 4.8m long & 1.2m high Fixed to the factory wall. See 'South Elevation' on page 5 of planning drawings.	

C1.6.1 Design & siting of signs	Met?	Acceptable Solutions A2	Met?	Comments
Continued	Yes	A sign must be not less than 2m from the boundary of any lot in the General Residential Zone, Inner Residential Zone, Low Density Residential Zone, Rural Living Zone or Landscape Conservation Zone.	N/A	
	Met?	Performance Criteria P2	Met?	Comments
	Yes	A sign must not cause an unreasonable loss of amenity to adjoining residential properties, having regard to: (a) the topography of the site and the surrounding area; (b) the relative location of buildings, habitable rooms of dwellings and private open space; (c) any overshadowing;and (d) the nature and type of the sign.	Yes	The proposed sign is a wall sign fixed to the factory wall and does not affect the adjacent buildings or properties.
C1.6.1 Design & siting of signs	Met?	Acceptable Solutions A3	Met?	Comments
	Yes	The number of signs for each business or tenancy on a road frontage of a building must be no more than: (a) 1 of each sign type, unless otherwise stated in Table C1.6; (b) 1 window sign for each window; (c) 3 if the street frontage is less than 20m in length; and (d) 6 if the street frontage is 20m or more, excluding the following sign types, for which there is no limit: (i) name plate; and (ii) temporary sign.	Yes	Only 1 large sign is proposed.
	Met?	Performance Criteria P3	Met?	Comments
	Yes	The number of signs for each business or tenancy on a street frontage must: (a) not unreasonably increase in the existing level of visual clutter in the streetscape, and where possible, reduce any existing visual clutter in the streetscape by replacing existing signs with fewer, more effective signs; and (b) not involve the repetition of messages or information.	Yes	Only 1 large sign is proposed.

19. General Industrial Zone C2.0 Parking & Sustainable Transport Code						
Objective: That an appropriate level of car parking spaces are provided to meet the needs of the use.	Yes	The number of on-site car parking spaces must be no less than the number specified in Table 2.1,	Yes	1 space per 200m ² of floor area or 2 spaces per 3 employees, whichever is greater.		
	Met?	Performance Criteria P1	Met?	Comments		
	Yes	<ul> <li>P1.1 The number of on-site car parking spaces for uses, excluding dwellings, must meet the reasonable needs of the use.</li> <li>P1.2 The number of car parking spaces for dwellings must meet the reasonable needs of the use, having regard to:</li> <li>(a) the nature and intensity of the use and car parking required;</li> <li>(b) the size of the dwelling and the number of bedrooms;and</li> <li>(c) the pattern of parking in the surrounding area.</li> </ul>	Yes	The existing factory shed is considered to come under the category of 'Manufacturing & Processing' according to Table C2.1 (Parking Space Requirements) With 406m2 of floor space and no more than 4 workers there is more than adequate number of car spaces. (10)		
C2.5.4 Loading Bays	Met?	Acceptable Solutions A1	Met?	Comments		
Objective: That adequate access for goods delivery and collection is provided, and to avoid unreasonable loss of amenity and adverse impacts on traffic flows.	Yes	A loading bay must be provided for uses with a floor area of more than 1000m ² in a single occupancy.	Yes	The development has adequate loading space for the floor area of approx. 400m2.		
	Met?	Performance Criteria P1	Met?	Comments		
	Yes	Adequate space for loading and unloading of vehicles must be provided, having regard to: (a) the type of vehicles associated with the use; (b) the nature of the use; (c) the frequency of loading and unloading; (d) the location of the site; (e) the nature of traffic in the surrounding area; (f) the area and dimensions of the site; and (g) the topography of the site; (h) the location of existing buildings on the site; and (i) any constraints imposed by existing development.	Yes	The site & development has been specifically chosen & designed to accommodate the loading of modular homes & cabins by heavy duty vehicles. There is adequate space at the site for this purpose.		

C2.6.1 Construction of parking areas	Met?	Acceptable Solutions A1	Met?	Comments
Objective: That parking areas are constructed to an appropriate standard.	Yes	All parking, access ways, manoeuvring and circulation spaces must: (a) be constructed with a durable all weather pavement; (b) be drained to the public stormwater system, or contain stormwater on the site;and (c) excluding all uses in the Rural Zone, Agriculture Zone, Landscape Conservation Zone, Environmental Management Zone, Recreation Zone and Open Space Zone, be surfaced by a spray seal, asphalt, concrete, pavers or equivalent material to restrict abrasion from traffic and minimise entry of water to the pavement.	Yes	Parking & access ways are constructed with permeable decomposed compacted granite that assists the drainage to avoid overloading the public stormwater system.
	Met?	Performance Criteria P1	Met?	Comments
	Yes	All parking, access ways, manoeuvring and circulation spaces must be readily identifiable and constructed so that they are useable in all weather conditions, having regard to: (a) the nature of the use; (b) the topography of the land; (c) the drainage system available; (d) the likelihood of transporting sediment or debris from the site onto a road or public place; (e) the likelihood of generating dust;and (f) the nature of the proposed surfacing	Yes	All parking areas and circulation spaces are identifiable and able to stand up to all weather conditions.

C2.6.2		Acceptable Solutions A1		
Design and layout of parking areas				
Objective: That parking areas are designed and laid out to provide convenient, safe and efficient parking.	Yes	<ul> <li>A1.1</li> <li>Parking, access ways, manoeuvring and circulation spaces must either: <ul> <li>(a) comply with the following:</li> <li>(i) have a gradient in accordance with <i>Australian Standard AS 2890 - Parking facilities</i>,</li> <li>(ii) provide for vehicles to enter and exit the site in a forward direction where providing for more than 4 parking spaces;</li> <li>dimensions which satisfy the requirements in Table C2.3;</li> <li>(v) have a combined access and manoeuvring width adjacent to parking spaces not less than the requirements in Table C2.3 where there are 3 or more car parking spaces;</li> <li>(vi) have a vertical clearance of not less than 2.1m above the parking surface level; and</li> <li>(vii) excluding a single dwelling, be delineated by line marking or other clear physical means; or</li> <li>(b) comply with <i>Australian Standard AS 2890- Parking facilities, Parts 1-6.</i></li> </ul></li></ul>	Yes	The gradient of driveway, parking, and turning areas are graded in accordance with AS2890, The turning area allows large vehicles with bulky loads to enter & exit the site in a forward direction.
		A1.2 Parking spaces provided for use by persons with a disability must satisfy the following: (a) be located as close as practicable to the main entry point to the building; (b) be incorporated into the overall car park design; and (c) be designed and constructed in accordance with Australian/New Zealand Standard AS/NZS 2890.6:2009 Parking facilities, Off-street parking for people with disabilities.1	Yes	Cars can park close to the factory near the entrance of the building factory & offices.
		Performance Criteria P1		
	Yes	All parking, access ways, manoeuvring and circulation spaces must be designed and readily identifiable to provide convenient, safe and efficient parking, having regard to: (a) the characteristics of the site; (b) the proposed slope, dimensions and layout; (c) useability in all weather conditions; (d) vehicle and pedestrian traffic safety; (e) the nature and use of the development; (f) the expected number and type of vehicles; (g) the likely use of the parking areas by persons with a disability; (h) the nature of traffic in the surrounding area;	Yes	All parking, access ways, and circulation spaces are easy to identify and use by drivers and pedestrians.

C2.6.6 Loading Bays		Acceptable Solutions A1		Comments
Objective: That the area and dimensions of loading bays are adequate to provide safe and efficient delivery and collection of goods.	Yes	The area and dimensions of loading bays and access way areas must be designed in accordance with Australian Standard AS 2890.2–2002, Parking facilities, Part 2: Off-street commercial vehicle facilities, for the type of vehicles likely to use the site.	Yes	The site & development has been specifically chosen & designed to accommodate the loading of modular homes & cabins by heavy duty vehicles. There is adequate space at the site for this purpose.
		Performance Criteria P1		Comments
	Yes	Loading bays must have an area and dimensions suitable for the use, having regard to: (a) the types of vehicles likely to use the site; (b) the nature of the use; (c) the frequency of loading and unloading; (d) the area and dimensions of the site; (e) the topography of the site; (f) the location of existing buildings on the site; and (g) any constraints imposed by existing development.	Yes	Space exists for vehicle turning circles for the type of vehicles likely to use the site. A large roller door 8m wide & 5m high will provide loading access to the factory. (see floor plans & elevations of drawings)
		Acceptable Solutions A2		Comments
	Yes	The type of commercial vehicles likely to use the site must be able to enter, park and exit the site in a forward direction in accordance with <i>Australian Standard</i> <i>AS 2890.2 – 2002, Parking Facilities,</i> <i>Part 2: Parking facilities Offstreet</i> <i>commercial vehicle facilities.</i>	Yes	The turning area allows large vehicles with bulky loads to enter & exit the site in a forward direction.
		Performance Criteria P1		Comments
	Yes	Access for commercial vehicles to and from the site must be safe, having regard to: (a) the types of vehicles associated with the use;	Yes	Access to the area allows for large commercial vehicles to enter & exit the site with no constraints.

### **C9.0 Attenuation Code**

C9.5.1 Activities with potential to cause emissions	Met?	Acceptable Solutions A1	Met?	Comments
Objective: That an activity with potential to cause emissions is located so that it does not cause an unreasonable impact on an existing sensitive use.	Yes	The attenuation area of an activity listed in Tables C9.1 or C9.2 must not include: (a) a site used for a sensitive use which is existing; (b) a site that has a planning permit for a sensitive use; or (c) land within the General Residential Zone, Inner Residential Zone, Low Density Residential Zone, Rural Living Zone A, Rural Living Zone B, Village Zone or Urban Mixed Use Zone.	Yes	
		Performance Criteria P1		Comments
	Yes	An activity listed in Tables C9.1 or C9.2 must not cause: (a) an unreasonable loss of amenity or unreasonable impacts on health and safety of a sensitive use which is existing, or has a planning permit; or (b) unreasonable impacts on land within the relevant attenuation area that is in the General Residential Zone, Inner Residential Zone, Low Density Residential Zone, Rural Living Zone A, Rural Living Zone B, Village Zone or Urban Mixed Use Zone, having regard to: (i) operational characteristics of the activity; (ii) degree of hazard or pollution that may be emitted from the activity; (iv) hours of operation of the activity; (v) nature of likely emissions such as noise, odour, gases, dust, particulates, radiation, vibrations or waste; (vi) existing emissions such as noise, odour, gases, dust, particulates, radiation, vibrations or waste; and (vii) measures to eliminate, mitigate or manage emissions from the activity.	Yes	

C9.5.2 Sensitive use within an attenuation area	Met?	Acceptable Solutions A1	Met?	Comments
Objective: That sensitive use located within an attenuation area does not interfere with or constrain the operation of an existing activity listed in Tables C9.1 or C9.2.		No Acceptable Solution.		
		Performance Criteria P1		Comments
	Yes	Sensitive use within an attenuation area, must not interfere with or constrain an existing activity listed in Tables C9.1 or C9.2, having regard to: (a) the nature of the activity with potential to cause emissions including: (i) operational characteristics of the activity; (ii) scale and intensity of the activity; and (iii) degree of hazard or pollution that may be emitted from the activity; (b) the nature of the sensitive use; (c) the extent of encroachment by the sensitive use into the attenuation area; (d) measures in the design, layout and construction of the development for the sensitive use to eliminate, mitigate or manage effects of emissions of the activity; (e) any advice from the Director, Environment Protection Authority; and (f) any advice from the Director of Mines.	Yes	